SITE LEASE AGREEMENT

This **SITE LEASE AGREEMENT** (this "**Lease**") is effective the date of the last signature on this Lease (the "**Effective Date**") by and between the **CITY OF BRIGHTON, COLORADO, a Colorado** , a Colorado home rule municipal corporation ("**Landlord**") and **T-Mobile West LLC**, a Delaware limited liability company ("**Tenant**").

RECITALS

Landlord and Tenant acknowledge that space at the Premises was previously leased between Landlord and Tenant's affiliate, under the terms and conditions of that certain Communications Site Lease Agreement (Water Tank) dated December 15, 2006 as may have been amended (collectively, the "Prior Lease"). The Prior Lease expired by its terms on December 13, 2021 and Tenant has continued to operate on a month to month basis at the Premises under the terms of the Prior Lease with Landlord's consent. Landlord and Tenant acknowledge and agree that the Prior Lease shall terminate effective as of 11:59:59 pm on the day immediately prior to the Commencement Date of this Lease ("Prior Lease Termination Date") as if such date were originally stated to be the termination date of the Prior Lease and shall thereafter be replaced in its entirety by this Lease. The termination of the Prior Lease shall be effective without further documentation. Any rent payments received by Landlord pursuant to the Prior Lease for periods following the Prior Lease Termination Date will be applied as a credit against the Rent due and owing pursuant to this Lease.

Landlord and Tenant agree to the following:

- 1. Property Description. Landlord is the owner of the real property and water tank structure ("WaterTank") located at 19150 E. 160th Ave. (APN: 0156910212001), Brighton, Adams County, Colorado 80601, as further described on Exhibit A (the "Property"). The Property includes approximately nine hundred square feet (900sf) plus any additional portions of the Property which Tenant may require for the use and operation of its facilities, as generally described on Exhibit B (the "Premises"). In addition to the square footage specified above, the Premises, as defined, shall include, but not be limited to, the following: a back up generator, cable runs and associated cable trays from the base transceiver station(s) (also referred to as the BTS) and the installation of power, telephone and other utility service cables. However, it is expressly agreed that the exact and precise location of the Tenant's Antenna Facilities (as defined below) are subject to review and approval by the planning and/or zoning boards having jurisdiction over the Property. The specific locations, number and type of equipment described in Exhibit B is for illustrative purposes only and in no way limits Tenant's ability to alter, replace, add to, enhance, modify, supplement, replace, or upgrade.
- 2. <u>Landlord Cooperation</u>. After the Effective Date, Landlord shall cooperate with Tenant's due diligence activities, which shall include, but not be limited to, access to the Property for inspections, testing, permitting related to the Permitted Uses (as defined below). Tenant is authorized to sign, file, submit and obtain all zoning, land use and other applications for permits, licenses and approvals required for the Permitted Uses from all applicable governmental and quasi-governmental entities (collectively, the "<u>Governmental Approvals</u>"), and to the fullest extent necessary Landlord grants Tenant and its agents power of attorney to take all such actions on behalf of and in the name of Landlord. Landlord's cooperation shall include the prompt execution and delivery of any documents necessary to obtain and maintain Governmental Approvals or utility services. Landlord shall not take any actions which are in conflict with or interfere with Tenant's Governmental Approvals.

1

Site Number: DN06027A/DN73XC079
Site Name: City of Brighton Water Tank

3. Antenna Facilities and Permitted Uses. Tenant leases the Premises for its equipment, personal property and improvements associated with Tenant's wireless communications business (the "Antenna Facilities"). The Premises may be used for the construction, installation, operation, maintenance, repair, addition, modification, enhancement, upgrading, removal, or replacement of any and all Antenna Facilities (the "Permitted Uses") for no fee or additional consideration. Notwithstanding the foregoing Tenant shall have the right to expand and/or relocate the Antenna Facilities after obtaining the written approval of Landlord, which shall not be unreasonably withheld, conditioned, or delayed. The Antenna Facilities shall remain the exclusive property of Tenant and shall not be considered fixtures. Tenant, at its expense, may use any and all reasonable means as Tenant deems necessary to control, secure or restrict access to the Antenna Facilities, provided such means do not interfere with Landlord's access to and use of the Property. Landlord hereby waives any and all lien rights it may have concerning the Antenna Facilities. If necessary to maintain service, Tenant shall have the right to locate a temporary antenna facility, (e.g. a cell-on-wheels) on the Property, including all utilities associated with the use of the temporary antenna facility. Landlord shall cooperate with the placement of the temporary facility at a mutually acceptable location.

4. Lease Term.

- a) The Initial Term of the Lease shall be ten (10) years commencing on the Effective Date (the "<u>Commencement Date</u>"), and ending on the day immediately preceding the tenth (10th) anniversary of the Commencement Date (the "<u>Initial Term</u>"). The Initial Term, together with any Renewal Terms and Extended Periods are referred to collectively as the "<u>Term</u>."
- b) The Initial Term shall automatically renew for two (2) successive renewal terms of five (5) years each (each a "Renewal Term"), provided, however, that Tenant may elect not to renew after the Initial Term, by providing at least ninety (90) days notice prior to the expiration of the then current Term. Landlord may elect not to renew by providing at least six (6) months notice prior to the expiration of the then current Term and/or Renewal Term.
- c) Upon the expiration of the final Renewal Term, Tenant shall have the right to continue to occupy the Premises and the Term shall automatically extend for up to two (2) successive one (1) year periods (each, an "Extended Period"). Landlord may elect not to renew by providing notice to Tenant at least six (6) months prior to the expiration of the then current Extended Period. Tenant may terminate any Extended Period at any time by delivery of notice to Landlord.

5. Rent/Other Charges.

- a) Upon the Commencement Date, Tenant shall pay Landlord rent in the amount of amount of two thousand five hundred dollars (\$2,500.00) per month (the "Rent"). Tenant shall deliver Rent to Landlord at the address specified in the Notice section, or by electronic payment. The first Rent payment shall be due within thirty (30) days after the Commencement Date. Subsequent Rent shall be payable by the fifth day of each month.
- b) Upon the anniversary of the Commencement Date, the Rent shall automatically be increased by three (3%) percent of the Rent for the immediately preceding year throughout the Term and any subsequent Renewal Term or Extended Period without further documentation.

Site Number: DN06027A/DN73XC079
Site Name: City of Brighton Water Tank

- c) Rent for any partial month shall be prorated on a per day basis, based on the number of days in the month in question. Landlord shall cooperate with Tenant regarding the use of any electronic rent payment systems or the provision of any associated documentation. Tenant may condition payment of Rent and any other sums payable under this Lease upon Tenant's receipt of a duly completed IRS form W-9, or similar governmental form.
- d) Any charges payable under this Lease other than Rent shall be billed by Landlord to Tenant within twelve (12) months from the date the charges were incurred or due; otherwise the charges shall be deemed time-barred and forever waived and released by Landlord. Additionally, if it is determined by Tenant that Tenant overpaid Landlord for any charges due under the Lease, Tenant is permitted, upon written notice to Landlord, to deduct any such overpayment from Rent amounts due under this Lease.
- 7. <u>Interference.</u> Tenant shall not interfere with the radio frequency communications of Landlord or any of Landlord's existing tenants as of the Effective Date. After the Effective Date, Landlord shall not install, or permit any third party to install, any equipment or structures that unreasonably interfere with or restrict the operations of Tenant. Any such interference shall be deemed a material breach of this Lease by Landlord and Landlord shall remove the cause of the interference within forty-eight (48) hours of notice notwithstanding any other cure periods in this Lease. Tenant shall have the right to exercise all legal and equitable rights and remedies to end the interference, including the right to terminate this Lease.
- 8. <u>Utility Services.</u> Tenant shall have the right to connect to, maintain, repair, modify, upgrade, remove or replace existing utility related equipment and/or construct and install new utility related equipment and lines, including a generator, optical fiber facilities and alternative energy related equipment, to service its Antenna Facilities (collectively, the "<u>Utility Facilities</u>"). The Utility Facilities may be brought by Tenant to the Property and the Premises, and the charges for utility usage (the "<u>Utility Fees</u>") shall be payable, by one of the following methods:
- a) **Separate Meter**. Tenant may install a separate meter at any time during the Term of the Lease and will remit payment directly to the utility provider.

b) Submeter

- (i) **Smart Submeter**. Tenant may install a submeter that can be remotely managed and read ("<u>Smart Submeter</u>"). The Smart Submeter will be read on a **regular/ quarterly** basis and Tenant will be directly invoiced for its Utility Fees, with a copy provided to Landlord's email address. Tenant will remit payment to the Landlord within thirty (30) days of receipt of the invoice; or
- (ii) **Manually-Read Submeter.** Tenant may install a sub-meter to monitor Tenant's electrical usage which will be read by Landlord on a monthly basis and which determine Tenant's actual electrical usage. Tenant shall pay to Landlord on a monthly basis for such actual usage within 30 days of receipt of an invoice. The invoice must list the current and previous readings along with the kWh cost, and the building utility invoice must accompany the invoice.
- c) If Tenant does not install a separate meter or submeter, Tenant shall pay Landlord Utilities Fees in the amount of Three Hundred Dollars (\$300.00) per month for its utility usage when usage commences.

9. Access and Easements.

Site Number: DN06027A/DN73XC079
Site Name: City of Brighton Water Tank

- a) Landlord shall furnish, at no additional charge to Tenant, unimpeded and secure access to the Premises including the Utility Facilities on a 24-hours-a-day, 7-days-a-week basis to Tenant and Tenant's employees, agents, contractors and other designees. In the event that Landlord does not provide Tenant with access as described, Rent will be abated for the time period where Tenant was denied access to the Antenna Facilities.
- b) Upon the Effective Date, Landlord shall provide all applicable access key(s) and a defined and accessible location on the Property for Tenant to install a secure lockbox to store any such access key(s) necessary to allow for 24-hours-a-day, 7-days-a-week physical access to all of Tenant's equipment or conduits. Landlord shall not change the method(s) of access or access key(s), without providing Tenant prior written notice and an updated set of access keys or new access code(s).
- c) Landlord grants Tenant, at no additional Rent or charge, easements on, over, under and across the Property for ingress, egress, communications, power and other utilities, installation, construction, demolition and access to the Premises and any Utility Facilities (collectively, the "Easements"). Landlord shall not modify, interrupt or interfere with any access, communications, electricity, or other utility equipment and Easements serving the Property, except with the prior written approval of Tenant.
- d) Landlord acknowledges that denial of access may adversely impact Tenant's requirement as an FCC licensee to provide 9-1-1 emergency calling services and may adversely impact Tenant's ability to provide wireless services to its customers. Failure to provide Tenant access to the Premises, as required above, within 24 hours after receiving written notice of such failure shall be deemed a material Default. In the event Landlord, its employees or agents impede or deny access to Tenant, its employees or agents, Tenant shall, without waiving any other rights that it may have at law or in equity, have the right to deduct from the Rent due under this Lease five hundred and no/100 dollars (\$500.00) per day for each day that access is impeded or denied.
- 10. <u>Termination</u>. Tenant may terminate this Lease upon ninety (90) days prior written notice to Landlord, for any of the following reasons: (i) changes in local or state laws or regulations which adversely affect Tenant's ability to operate; (ii) a Federal Communications Commission ("<u>FCC</u>") ruling or regulation that is beyond the control of Tenant; (iii) in its sole discretion for technical, or economic reasons; or (iv) if Tenant is unable to obtain or maintain any Governmental Approval required for the construction or operation of Tenant's Antenna Facilities. Upon one hundred eighty (180) days prior written notice to Landlord, Tenant may terminate this Lease for any or no reason.
- 11. Casualty and Condemnation. If the Premises or Antenna Facilities are damaged or destroyed by wind, fire or other casualty, Tenant shall be entitled to negotiate, compromise, receive and retain all proceeds of Tenant's insurance and other claims and Tenant may terminate the Lease by written notice to Landlord. If the Premises, any Easements or Antenna Facilities are taken or condemned by power of eminent domain or other governmental taking, then: (a) Tenant shall be entitled to negotiate, compromise, receive and retain all awards attributable to (i) the Antenna Facilities, (ii) Tenant's leasehold interest in the Property, (iii) any moving or relocation benefit available to Tenant and (iv) any other award available to Tenant that is not attributable to Landlord's title to or interest in the Property. If the Antenna Facilities are not operational or accessible, due to casualty, condemnation, or damages, Tenant shall have the right to abate the Rent for that period time. In addition, Tenant may terminate the Lease by written notice to Landlord.

12. Default and Right to Cure.

Site Number: DN06027A/DN73XC079
Site Name: City of Brighton Water Tank

- (a) The following will be deemed a default by Tenant and a breach of this Lease (i) non-payment of Rent if such Rent remains unpaid for more than thirty (30) days after receipt of written notice from Landlord of such failure to pay; or (ii) Tenant's failure to perform any other term or condition under this Lease within thirty (30) days after receipt of written notice from Landlord specifying the failure. No such failure, however, will be deemed to exist if Tenant has commenced to cure such default within such period and provided that such efforts are prosecuted to completion with reasonable diligence. Delay in curing a default will be excused if due to causes beyond the reasonable control of Tenant.
- (b) The following will be deemed a default by Landlord and a breach of this Lease. Landlord's failure to perform any term, condition or breach of any warranty or covenant under this Lease within thirty (30) days after receipt of written notice from Tenant specifying the failure. No such failure, however, will be deemed to exist if Landlord has commenced to cure the default within such period and provided such efforts are prosecuted to completion with reasonable diligence. Delay in curing a default will be excused if due to causes beyond the reasonable control of Landlord.
- 13. <u>Taxes.</u> Landlord shall pay when due all real estate taxes and assessments for the Property, including the Premises. Notwithstanding the foregoing, Tenant shall reimburse Landlord for any personal property tax paid for by Landlord which is solely and directly attributable to the presence or installation of Tenant's Antenna Facilities during the Term. Landlord shall provide notice of any tax or assessment within fifteen (15) days for which Tenant is liable in whole or in part. Tenant shall have the right to challenge any tax or assessment and Landlord shall cooperate with Tenant regarding such challenge. In the event that Landlord fails to pay any taxes or other fees and assessments for the Property, including the Premises, Tenant shall have the right, but not the obligation, to pay such owed amounts and deduct them from Rent amounts due under this Lease. Landlord shall provide Tenant with written notice of any taxes due that Landlord fails to pay.

14. Insurance and Subrogation and Indemnification.

- a) During the Term, Tenant and Landlord each shall maintain Commercial General Liability Insurance in amounts of One Million and no/100 Dollars (\$1,000,000.00) per occurrence and Two Million and no/100 Dollars (\$2,000,000.00) aggregate. Each party may satisfy this requirement by obtaining the appropriate endorsement to any master insurance policy such party may maintain. Tenant and Landlord shall each maintain "all risk" or "special causes of loss" property insurance on a replacement cost basis for their respectively owned real or personal property.
- b) Landlord and Tenant hereby mutually release each other (and their successors or assigns) from liability and waive all right of recovery against the other for any loss or damage covered by their respective first party property insurance policies for all perils insured thereunder. In the event of an insured loss, neither party's insurance company shall have a subrogated claim against the other party.
- c) Subject to the property insurance waivers set forth in the preceding subsection (b), Tenant agrees to indemnify and hold harmless Landlord from and against any and all administrative and judicial actions and rulings, claims, causes of action, demands and liabilities, including reasonable attorneys' fees, to the extent caused by or arising out of: (i) any negligent acts or omissions or willful misconduct in the operations or activities on the Property by Tenant or the employees, agents, contractors, licensees, tenants or subtenants of Tenant, (ii) any spill or other release of any Hazardous Substances (as defined below) on the Property by Tenant or the employees, agents, contractors, licensees, tenants or subtenants of Tenant, or (iii) any breach of any obligation

Site Number: DN06027A/DN73XC079
Site Name: City of Brighton Water Tank

of Tenant under this Lease. Tenant's obligations under this subsection are contingent upon its receiving prompt written notice of any event giving rise to an obligation to indemnify Landlord and Landlord granting it the right to control the defense and settlement of the same. In no event shall either party be liable for any consequential, special, indirect or punitive damages or causes of loss, whether arising from breach of strict liability, contract, tort or otherwise, and regardless of whether or not such party was advised of, or should have known, the possibility of such damages.

- d) Tenant shall not be responsible or liable to Landlord or any third party for any claims, damages, costs, expenses, including liens, fines, penalties or other enforcement actions, attributable to any preexisting violations of applicable laws, codes, ordinances or other regulations relating to the Property (collectively, "Pre-Existing Violations"). To the extent Tenant is or may be required to cure such Pre-Existing Violations in order to obtain any Governmental Approvals for its Permitted Uses of the Premises, Tenant shall have the right, but not the obligation, to cure such Pre-Existing Violations and deduct the curative costs from Rent payable under this Lease.
- e) Tenant shall be responsible for any costs of repair, maintenance, or damage directly attributed to the Permitted Uses. Further, Tenant shall not directly or indirectly cause, create, incur, assume, or suffer to exist any notices of claim or claim of any nature with respect to the Property. In the event Tenant breaches this obligation, it shall immediately notify Landlord in writing, shall promptly cause such notice of claim to be discharged and released without cost to Landlord, and shall defend and indemnify Landlord in accordance with the provisions of subsection (c) above.
- f) In the event of damage to the Property by Tenant, Tenant shall promptly repair and maintain the Property to the reasonable satisfaction of Landlord, or alternatively, Landlord may, upon fifteen (15) days written notice to Tenant, perform or cause to be performed such repair and maintenance and Tenant shall promptly reimburse Landlord for the actual costs and expenses of such repair and maintenance. Determination of whether repair or maintenance to the Property is necessary or advisable and the nature and extent of such repair or maintenance shall be in the Landlord's reasonable discretion. In order to be reimbursed for such repairs and/or maintenance, Landlord shall provide to Tenant copies of all invoices for such repairs and/or maintenance within sixty (60) days of the date of the repairs and/or maintenance, and Tenant shall pay the same within sixty (60) days of receipt of such invoices and supporting documentation.
- g) The provisions of subsections (b) and (c) above shall survive the expiration or termination of this Lease.
- Notices. All notices, requests, demands and other communications shall be in writing and shall be effective three (3) business days after deposit in the U.S. mail, certified, return receipt requested or upon receipt if personally delivered or sent via a nationally recognized courier to the addresses set forth below. Landlord or Tenant may from time to time designate any other address for this purpose by providing written notice to the other party.

If to Tenant, to:

T-Mobile USA, Inc. 12920 SE 38th Street Bellevue, WA 98006 Attn: Lease

Compliance/DN06027A/DN73XC079

If to Landlord, to:

City of Brighton 500 S. 4th Avenue Brighton, CO 80601

Attn: City Manager

Site Number: DN06027A/DN73XC079 Site Name: City of Brighton Water Tank

Per the W-9 Form, Rent is to be paid to:

City of Brighton 500 S. 4th Avenue Brighton, CO 80601

- 16. Quiet Enjoyment, Title and Authority. Landlord covenants and warrants that: (a) Landlord has full right, power and authority to execute and perform this Lease to grant Tenant the leasehold interest and Easements contemplated under this Lease; (b) Landlord has good and unencumbered title to the Property, free and clear of any liens and will not interfere with Tenant's Permitted Uses and any rights under this Lease; (c) the execution and performance of this Lease shall not violate any laws, ordinances, covenants, or the provisions of any Mortgage, lease, or other agreement binding on Landlord; (d) Tenant's use and quiet enjoyment of the Premises will not be disturbed; and (e) Landlord will be responsible, at its sole cost and expense, for maintaining all portions of the Property, except for Tenant's Antenna Facilities and equipment, in good order and condition and in compliance with all applicable laws, including without limitation, the roof and its weatherproof membrane, any support structure owned by Landlord, HVAC, plumbing, elevators, landscaping and common areas.
- 17. Environmental Laws. Landlord and Tenant shall comply with all federal, state and local laws in connection with any substances brought onto the Property that are identified by any law, ordinance or regulation as hazardous, toxic or dangerous (collectively, the "Hazardous Substances"). Tenant agrees to be responsible for all losses or damage caused by any Hazardous Substances that it may bring onto the Property and will indemnify Landlord for all such losses or damages. Landlord agrees to be responsible for all losses or damage caused by any Hazardous Substances on or entering the Property, except those brought onto the Property by Tenant, and, to the extent permitted by Colorado law, will indemnify Tenant for all such losses or damages including the cost of any investigation or remediation, or other actions required to comply with applicable law. Landlord represents that it has no knowledge of any Hazardous Substances on the Property.

18. Assignment.

a) Tenant shall have the right to assign, sublease or otherwise transfer this Lease, upon written notice to Landlord. Tenant shall also have the right to provide access and easement rights existing under this Lease, for the purposes of bringing in Utility Facilities, including fiber equipment. Upon an assignment or transfer, Tenant shall be relieved of all liabilities and obligations and Landlord shall look solely to the transferee for performance under this Lease. Upon receipt of a written request from Tenant, Landlord shall promptly execute an estoppel certificate.

Landlord shall have the right to assign and transfer this Lease only to a successor owner of the Property. Only upon Tenant's receipt of written verification of a sale, or transfer of the Property shall Landlord be relieved of all liabilities and obligations and Tenant shall look solely to the new landlord for performance under this Lease. Until Tenant receives required information and documents, Tenant shall not be responsible for any failure to make payments under this Lease and reserves the right to hold payments due under this Lease. Landlord shall not attempt to assign, or otherwise transfer this Lease separate from a transfer of ownership of the Property (the "Severance Transaction"), without the prior written consent of Tenant, which consent may not be unreasonably withheld. If Tenant consents to a Severance Transaction, Landlord shall be relieved of all liabilities and obligations and Tenant shall look solely to the new landlord for performance under this Lease.

Site Number: DN06027A/DN73XC079
Site Name: City of Brighton Water Tank

19. Relocation.

- a) Landlord must provide Tenant at least twelve (12) months written notice of any repairs, maintenance or other work (the "Work") during the Term of the Lease which would require the temporary relocation of the Antenna Facilities. Landlord agrees that the Work will not limit or interfere with Tenant's Permitted Uses of the Premises. Tenant shall be solely responsible for all expenses incurred by Tenant required to accommodate the Work once per each five (5) year term and Landlord shall impose no additional fees, considerations, or conditions upon Tenant. If additional maintenance is required by Landlord within a five (5) year term, the costs to relocate the equipment will be shared equally by Tenant and Landlord. If necessary, in Tenant's sole determination, Tenant may elect to install a temporary communications facility (e.g. a "cell on wheels," or "COW") in another mutually agreeable location on the Property that provides Tenant coverage and service levels similar to those of the Antenna Facilities at the original location, while the Work is being performed. Tenant shall have the right to reinstall its Antenna Facilities immediately upon the completion of the Work. Tenant or its designee shall have the right to accompany Landlord, its agents or contractors whenever the Work is being performed on the Premises. Notwithstanding anything to the contrary, Landlord shall not have the right to permanently relocate the Antenna Facilities except as set forth herein.
- b) If Landlord desires to redevelop, modify, remodel, or in any way alter its Property or any improvements thereon ("Redevelopment"), Landlord shall in good faith use its best efforts to fully accommodate Tenant's continuing use of the Premises. If both parties to this Lease determine that the Redevelopment necessitates permanent relocation of the Antenna Facilities, Landlord shall have the right, subject to the following provisions of this section, to relocate the Antenna Facilities, or any part thereof, to an alternate location on the Property (the "Relocation Premises"), provided, however, that: (i) Landlord may only relocate Tenant once during the Lease; (ii) Landlord may only relocate Tenant after the Initial Term; (iii) Landlord must give Tenant at least twelve (12) months' written notice prior to such relocation; (iv) all costs and expenses associated with or arising out of such relocation (including, without limitation, approval and permitting costs) shall be paid by Landlord; (v) such relocation shall be performed exclusively by Tenant or its agents; and (vi) such relocation shall not limit or interfere with Tenant's Permitted Uses of the Premises. Landlord shall exercise its relocation right by delivering written notice to Tenant pursuant to the Lease and shall identify in the notice the proposed Relocation Premises on the Property. If, in Tenant's reasonable judgment, no suitable Relocation Premises can be identified on the Property, then Landlord shall not be permitted to exercise its relocation right under this section.
- 20. <u>Marking and Lighting Requirements</u>. If any tower or other support structure for Tenant's Antenna Facilities is owned by Landlord, Landlord acknowledges that Landlord shall be responsible for compliance with all marking and lighting requirements of the Federal Aviation Administration and the FCC. To the extent permitted by Colorado law, Landlord shall indemnify and hold Tenant harmless from any fines or other liabilities caused by Landlord's failure to comply with these requirements.

21. Miscellaneous.

a) This Lease constitutes the entire agreement and understanding of the parties, and supersedes all offers, negotiations and other agreements with respect to the subject matter and Property. Any amendments to this Lease must be in writing and executed by both parties.

Site Number: DN06027A/DN73XC079
Site Name: City of Brighton Water Tank

- b) Landlord agrees to cooperate with Tenant in executing any documents which Tenant deems necessary to insure and protect Tenant's rights in, or use of, the Premises. Landlord shall execute and deliver: (i) a Memorandum of Lease in substantially the form attached as **Exhibit C**; and (ii) if the Property is encumbered by a deed, mortgage or other security interest (each, a "**Mortgage**"), a subordination, non-disturbance and attornment agreement using Tenant's form.
- c) This Lease shall be construed in accordance with the laws of the state or territory in which the Property is located, without regard to the principles of conflicts of law.
- d) If any term of this Lease is found to be void or invalid, the remaining terms of this Lease shall continue in full force and effect. Any questions of particular interpretation shall be interpreted as to their fair meaning.
- e) Each party hereby represents and warrants to the other that this Lease has been duly authorized, executed and delivered by it, and that no consent or approval is required by any lender or other person or entity in connection with the execution or performance of this Lease.
- f) If either party is represented by any broker or any other leasing agent, such party is responsible for all commission fee or other payment to such agent.
- g) This Lease and the interests granted herein shall run with the land, and shall be binding upon and inure to the benefit of the parties, their respective successors, personal representatives and assigns.
- h) This Lease may be executed in any number of counterparts, each of which shall be deemed an original, but all of which together shall constitute a single instrument. Signed, scanned and emailed copy and electronic copies of this Lease shall legally bind the parties to the same extent as original documents.

[Remainder of page intentionally left blank; signature page follows.]

Site Number: DN06027A/DN73XC079
Site Name: City of Brighton Water Tank

LANDLORD: CITY OF BRIGHTON	
Ву:	<u> </u>
Printed Name: Michael Martinez	<u> </u>
Title: City Manager	<u> </u>
Date:	
ATTEST:	
Natalie Hoel, City Clerk	
APPROVED AS TO FORM:	
Yasmina Gibbons, Deputy City Attorney	
TENANT: T-MOBILE WEST LLC, a Delaware lim	ited liability company
By: Lucia Kenteria	
By:	
Title:Sr Director, Eng. Development	
5/22/2025 Date:	when we have a second and the second
InitialDS	T-Mobile Legal Approval

LF



Site Number: DN06027A/DN73XC079 Site Name: City of Brighton Water Tank

EXHIBIT A Legal Description

Property address of 19150 E. 160th Ave., Brighton, CO 80601 Assessor's tax parcel number 0156910212001

The Property is legally described as follows:
TRACT A, BRIGHTON CROSSING FILING NO.4,
CITY OF BRIGHTON, COUNTY OF ADAMS, STATE OF COLORADO

Site Number: DN06027A/DN73XC079 Site Name: City of Brighton Water Tank

EXHIBIT B

Subject to the terms and conditions of this Lease, the location of the Premises is generally described and depicted as shown below or in the immediately following attachment(s).

Site Number: DN06027A/DN73XC079 Site Name: City of Brighton Water Tank

T-MOBILE SITE # DN06027A

T-MOBILE PROJECT ID # DN06027A-0002391160

T-MOBILE SITE NAME **DN73XC079**



NATIONAL HARDENING PROJECT

SITE ADDRESS **4204 CRESTONE PEAK ST BRIGHTON, CO 80601**

> **FACILITY OWNER ID** DN73XC079

INTERNATIONAL BUILDING CODE 2021

INTERNATIONAL FUEL GAS CODE 2021

NATIONAL ELECTRICAL CODE 2023

MANUAL OF STEEL CONSTRUCTION

INTERNATIONAL MECHANICAL CODE 2021

INTERNATIONAL ENERGY CONSERVATION CODE 2021

INTERNATIONAL PROPERTY MAINTENANCE CODE 2021

INTERNATIONAL EXISTING BUILDING CODE 2021


REQUIREMENTS FOR TELECOMMUNICATIONS

GENERAL NOTES

APPLICABLE CODES



,	I	CHE	ECKED BY: RH	CHECKED BY: GMS				
	ı	REV	DESCRIPTION	DATE	INITIALS			
	ш	1	PCD'S	06/26/24	BK/MD/PM			
	Ш	2	FCD'S	01/14/25	SK/EG			

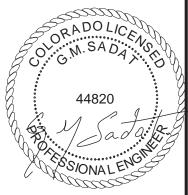

EXPIRATION: 10/31/2025

361 RANDY RD LINIT 101 CAROL STREAM II 60188 MAIN: (847) 708-7500

,	Ш	CHE	ECKED BY: RH	CHECKE	D BY: GMS
	ı	REV	DESCRIPTION	DATE	INITIALS
	Ш	1	PCD'S	06/26/24	BK/MD/PM
	Ш	2	FCD'S	01/14/25	SK/EG



SITE #: DN06027A DN73XC079 4204 CRESTONE PEAK ST

SHEET TITLE:

ı	CHE	ECKED BY: RH	CHECKED BY: GMS				
ı	REV	DESCRIPTION	DATE	INITIALS			
ı	1	PCD'S	06/26/24	BK/MD/PM			
ı	2	FCD'S	01/14/25	SK/EG			
ш							

DOWNERS GROVE, IL 60515

MAIN: (773) 444-5400

и.				
ı	REV	DESCRIPTION	DATE	INITIALS
ı	1	PCD'S	06/26/24	BK/MD/PM
ı	2	FCD'S	01/14/25	SK/EG
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SCOPE OF WORK

THE SCOPE OF WORK CONSISTS OF:

- INSTALLATION OF NEW 48KW GENERAC RD048 GENERATOR W/ 240 GALLON DIESEL TANK.
- INSTALLATION OF NEW AUTOMATIC TRANSFER SWITCH.
- INSTALLATION OF NEW 4'-0" X 9'-6" CONCRETE PAD
- 4. INSTALLATION OF (1) NEW 10 LB ABC FIRE EXTINGUISHER INSIDE WEATHERPROOF
- INSTALLATION OF NEW CONDUITS FOR POWER & COMMUNICATION FOR PROPOSED GENERATOR & AUTOMATIC TRANSFER SWITCH.
- INSTALLATION OF (1) NEW 20 AMP 1-POLE BREAKER FOR GENERATOR BLOCK
- HEATER & LABEL "GEN GFCI". REMOVAL OF UNSED BREAKER IN AC PANEL
- INSTALLATION OF EXHALIST PIPE EXTENSIONS
- . INSTALLATION OF VENT PIPE EXTENSIONS
- 10.INSTALLATIONS OF REMOTE EMERGENCY STOP BUTTON
- 11.INSTALLATION OF SPILL BOX W/ DRAIN BACK

DRIVING DIRECTIONS

PROFESSIONAL LICENSURE

DRIVING DIRECTIONS FROM DENVER INTERNATIONAL AIRPORT AT

- 8500 PEÑA BLVD, DENVER, CO 80249: HEAD EAST ON PEÑA BLVD 0.2 MI
- TAKE THE 75TH AVE EXIT 0.7 MI
- USE THE LEFT LANE TO TURN LEFT ONTO N GUN CLUB RD 0.4 MI
- TURN LEFT ONTO E 78TH AVE 0.1 MI
 CONTINUE ONTO E 78TH AVE CONNECTOR 0.6 MI
- MERGE ONTO PEÑA BLVD 0.4 MI
- TAKE EXIT 6B TOWARD BOULDER/FT.COLLINS TOLL ROAD 0.9 MI
- MERGE ONTO E-470 N TOLL ROAD 6.4 MI
- TAKE EXIT 35 TO MERGE ONTO 1-76 E TOWARD FT MORGAN 2.9 MI
- TAKE EXIT 21 FOR EAGLE BLVD 0.3 MI TURN LEFT ONTO EAGLE BOULEVARD 0.3 MI
- TURN RIGHT ONTO PRAIRIE CENTER PKWY 1.1 MI CONTINUE ONTO TOWER RD 0.5 MI
- CONTINUE ONTO S 40TH AVE 0.5 MI
- TURN RIGHT ONTO CO-7 0.2 MI TURN RIGHT ONTO N 42ND AVE 308 FT

DESTINATION WILL BE ON THE RIGHT TOTAL TRAVEL ESTIMATE: 15.6 MI, 21 MINS

I CERTIFY THAT THESE DRAWINGS WERE

PREPARED BY ME OR UNDER MY DIRECT


SUPERVISION AND CONTROL AND TO

THE BEST OF MY KNOWLEDGE AND

BELIEF COMPLY WITH THE REQUIREMENTS OF THE GOVERNING

LOCAL BUILDING CODE

SHEET INDEX SHEET DESCRIPTION TITLE SHEET SITE NOTES **GENERAL NOTES & SPECIFICATIONS** SITE PLAN A-1A GENERATOR ELEVATION SIGNAGE CONCRETE PAD DETAILS UTILITY PLAN AND DETAILS ONE LINE DIAGRAM ALARM SCHEDULE GROUNDING DETAILS GROUNDING DETAILS GENERATOR SPECIFICATIONS GENERATOR SPECIFICATIONS GENERATOR SPECIFICATIONS SPEC-4 GENERATOR SPECIFICATIONS SPEC-5 GENERATOR SPECIFICATIONS ATS SPECIFICATIONS ATS SPECIFICATIONS SPEC-8 SPILL BOX SPECIFICATIONS SPEC-9 VENT KIT SPECIFICATIONS SPEC-10 REMOTE EMERGENCY STOP SPECIFICATIONS

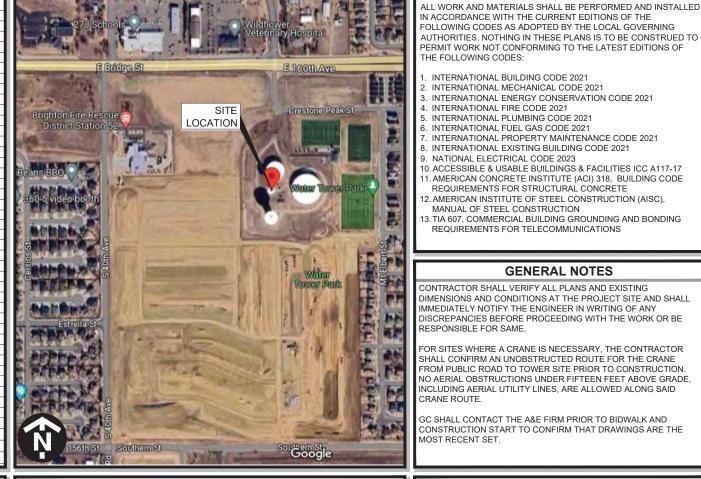

AERIAL MAP

UTILITY LOCATE SERVICE



Know what's helow Call 811 before you dig.

PROJECT CONTACTS

APPLICANT:

T- MOBILE 1400 OPUS PLACE DOWNERS GROVE, IL 60515 MAIN: (773) 444-5400

ENGINEERING CONCORDIA WIRELESS GM SADAT PF PHONE: (847) 708-7500 FAX: (847) 589-0643

ACILITY

LANDLORD

EMERGENCY

CITY OF BRIGHTON BRIGHTON, CO. 80601

(303) 655-2118

ACQUISITION CONTACT:

CONCORDIA WIRELESS PHONE: (224) 230-7191

SITE INFORMATION

ATITUDE: N 39° 59' 04.20" / 39.984500 (NAD 83) W 104° 46' 01.44" / -104.767068 (NAD 83) LONGITUDE

GROUND ELEVATION: ±5177' AMSL SITE TYPE: WATER TOWER JURISDICTION: CITY OF BRIGHTON COUNTY: ADAMS

156910212001

LICENSED PROFESSIONA LICENSE # PE.0044820

EXPIRES: 10/31/25

SIGNED: 01/14/25

BRIGHTON, CO 80601

TITLE SHEET

SHEET NUMBER:

T-1

\Rightarrow	NEW ANTENNA		GROUT OR PLASTER
757	EXISTING ANTENNA		(E) BRICK
\otimes	GROUND ROD		(E) MASONRY
	GROUND BUS BAR		CONCRETE
•	MECHANICAL GRND. CONN.		EARTH
	CAD WELD		GRAVEL
\boxtimes	GROUND ACCESS WELL		PLYWOOD
			SAND
E	ELECTRIC BOX		WOOD CONT.
T	TELEPHONE BOX		WOOD BLOCKING
\Rightarrow	LIGHT POLE		STEEL
0	FND. MONUMENT		CENTERLINE
<u> </u>			PROPERTY/LEASE LINE
•	SPOT ELEVATION		MATCH LINE
Δ	SET POINT	—	WORK POINT
1	REVISION	-··-	GROUND CONDUCTOR
(x)	GRID REFERENCE	$-\cdot - \text{UT} -\cdot -$	BELOW GRADE TELEPHONE CONDUIT
(X)		$- \cdot - \text{UE} - \cdot -$	BELOW GRADE ELECTRICAL CONDUIT
<u>x-x</u>	DETAIL REFERENCE	$-\cdot - A - \cdot -$	COAXIAL CABLE
X X-X	ELEVATION REFERENCE		OVERHEAD ELECTRIC/TELEPHONE CONDUCTORS CHAIN LINK FENCING


		ICCD	ICOLATED CODDED CDOUND BUG
ABV.	ABOVE	ICGB.	ISOLATED COPPER GROUND BUS
ADD'L	ADDITIONAL	IN.(")	INCH(ES)
A.F.F.	ABOVE FINISHED FLOOR	INT.	INTERIOR
		LB.(#)	
A.F.G.	ABOVE FINISHED GRADE		POUND(S)
ALUM.	ALUMINUM	L.F.	LINEAR FEET (FOOT)
ALT.	ALTERNATE	L.	LONG(ITUDINAL)
		MAS.	MASONRY
ANT.	ANTENNA		
APPROX.	APPROXIMATE(LY)	MAX.	MAXIMUM
ARCH.	ARCHITECT(URAL)	MDCMC	METRICOM DESIGNATED
ATS		in Bomo	
	AUTOMATIC TRANSFER SWITCH		CONSTRUCTION MANAGEMENT
AWG.	AMERICAN WIRE GAUGE		& CONTRACTING
BLDG.	BUILDING	MECH.	MECHANICAL
BLK.	BLOCK		
		MFR.	MANUFACTURER
BLKG.	BLOCKING	MIN.	MINIMUM
BM.	BEAM	MISC.	MISCELLANEOUS
BTCW.	BARE TINNED COPPER WIRE	MTL.	METAL
B.O.F.	BOTTOM OF FOOTING	(N)	NEW
B/U	BACK-UP CABINET	NÓ.(#)	NUMBER
CAB.	CABINET		
		N.T.S.	NOT TO SCALE
CANT.	CANTILEVER(ED)	O.C.	ON CENTER
C.I.P.	CAST IN PLACE	OPNG.	OPENING
CLG	CELING		
		PCS	PERSONAL COMMUNICATION SERVICES
CLR.	CLEAR	PLY.	PLYWOOD
COL.	COLUMN	PRC	PRIMARY RADIO CABINET
CONC.	CONCRETE		
		P.S.F.	POUNDS PER SQUARE FOOT
CONN.	CONNECTION(OR)	P.S.I.	POUNDS PER SQUARE INCH
CONST.	CONSTRUCTION	P.T.	PRESSURE TREATED
CONT.	CONTINUOUS	PWR.	
			POWER (CABINET)
DBL.	DOUBLE	QTY.	QUANTITY
DEPT.	DEPARTMENT	RAD.(R)	RADIUS
DIA.	DIAMETER	REF.	REFERENCE
DIAG.	DIAGONAL	REINF.	REINFORCEMENT(ING)
DIM.	DIMENSION	REQ'D.	REQUIRED
DWG.	DRAWING(S)	RGS.	RIGID GALVANIZED STEEL
DWL.	DOWEL(S)	SCH.	SCHEDULE
EA.	EACH	SHT.	SHEET
EL.	ELEVATION	SIM.	SIMILAR
ELEC.	ELECTRICAL	SPEC.	
			SPECIFICATION(S)
ELEV.	ELEVATOR	SQ.	SQUARE
EMT.	ELECTRICAL METALLIC TUBING	S.S.	STAINLESS STEEL
FNG.	FNGINEER	STD.	STANDARD
EQ.	EQUAL	STL.	STEEL
EXP.	EXPANSION	STRUC.	STRUCTURAL
EXIST.(E)	EXISTING	TEMP.	TEMPORARY
EXT.	EXTERIOR	THK.	THICK(NESS)
FAB.	FABRICATION(OR)	T.O.A.	TOP OF ANTENNA
F.F.	FINISH FLOOR	T.O.C.	TOP OF CURB
F.G.	FINISH GRADE	T.O.F.	
			TOP OF FOUNDATION
FIN.	FINISH(ED)	T.O.P.	TOP OF PLATE (PARAPET)
FLR.	FLOOR	T.O.S.	TOP OF STEEL
FDN.	FOUNDATION	T.O.W.	TOP OF WALL
F.O.C.	FACE OF CONCRETE	TYP.	TYPICAL
F.O.M.	FACE OF MASONRY	U.G.	UNDER GROUND
F.O.S.	FACE OF STUD	U.L.	UNDERWRITERS LABORATORY
F.O.W.	FACE OF WALL	U.N.O.	UNLESS NOTED OTHERWISE
F.S.	FINISH SURFACE	V.I.F.	VERIFY IN FIELD
FT.(')	FOOT(FEET)		
		W	WIDE(WIDTH)
FTG.	FOOTING	W/	WITH
G.	GROWTH (CABINET)	WAP.	WIRED ACCESSED POINT
GA.	GAUGE		
GL.		WCS	WIRELESS COMMUNICATION SERVICE
	GALVANIZE(D)	WT.	WEIGHT
G.F.I.	GROUND FAULT CIRCUIT INTERRUPTER	©	CENTERLINE
GPS	GLOBAL POSITIONING SYSTEM		PLATE
GND.	GROUND	PL	FLATE
HGR.	HANGER		





- REPRESENTATIVES OF THE OWNER MUST BE NOTIFIED AT LEAST TWO FULL DAYS PRIOR TO COMMENCEMENT OF CONSTRUCTION.
- 2. DO NOT EXCAVATE OR DISTURB BEYOND THE PROPERTY LINES OR LEASE LINES, UNLESS OTHERWISE NOTED.
- 3 DO NOT SCALE BUILDING DIMENSIONS FROM DRAWINGS
- 4. ANY DRAIN AND/OR FIELD TILE ENCOUNTERED DURING CONSTRUCTION SHALL BE RETURNED TO ITS ORIGINAL CONDITION PRIOR TO COMPLETION OF WORK. SIZE, LOCATION AND TYPE OF ANY UNDERGROUND UTILITIES OR IMPROVEMENTS SHALL BE ACCURATELY NOTED AND PLACED ON AS-CONSTRUCTED DRAWINGS AND ISSUED TO ARCHITECT/ENGINEER AT COMPLETION OF PROJECT.
- 5. ALL EXISTING UTILITIES. FACILITIES. CONDITIONS, AND THEIR DIMENSIONS SHOWN ON PLANS HAVE BEEN PLOTTED. ALL EXISTING UTILITIES, FACILITIES, CONDITIONS, AND THEIR DIMENSIONS SHOWN ON PLANS HAVE BEEN PLOTTED FROM AVAILABLE RECORDS. THE ARCHITECTHEN INDEER AND OWNER ASSUME NO RESPONSIBILITY WHATSOEVER AS TO THE SUFFICIENCY OR ACCURACY OF THE INFORMATION SHOWN ON THE PLANS OR THE MANNER OF THEIR REMOVAL OR ADJUSTMENT. CONTRACTOR SHALL BE RESPONSIBLE FOR DETERMINING EXACT LOCATION OF ALL EXISTING UTILITIES AND FACILITIES PRIOR TO STATE OF CONSTRUCTION. CONTRACTOR SHALL ALSO OBTAIN FROM EACH UTILITY COMPANY DETAILED INFORMATION RELATIVE TO WORKING SCHEDULES AND METHODS OF REMOVING OR ADJUSTING EXISTING UTILITIES.
- 6. CONTRACTOR SHALL VERIFY ALL EXISTING UTILITIES BOTH HORIZONTALLY AND VERTICALLY PRIOR TO START OF CONSTRUCTION. ANY DISCREPANCIES OR DOUBTS AS TO THE INTERPRETATION OF PLANS SHOULD BE IMMEDIATELY REPORTED TO THE ARCHITECTENGINEER FOR RESOLUTION AND INSTRUCTION, AND NO FURTHER WORK SHALL BE PERFORMED UNTIL THE DISCREPANCY IS CHECKED AND CORRECTED BY THE ARCHITECTENGINEER. FAILURE TO SECURE SUCH INSTRUCTION MEANS CONTRACTOR WILL HAVE WORKED AT HISHER OWN RISK AND EXPENSE. CONTRACTOR SHALL CALL PUBLICIPRIVATE UTILITY LOCATE FOR UTILITY LOCATIONS 46 HOURS PRIOR TO START OF CONSTRUCTION.
- ALL NEW AND EXISTING UTILITY STRUCTURES ON SITE AND IN AREAS TO BE DISTURBED BY CONSTRUCTION SHALL BE ADJUSTED TO FINISH ELEVATIONS PRIOR TO FINAL INSPECTION OF WORK.
- 8. THE BUILDING DEPARTMENT ISSUING THE BUILDING PERMIT SHALL BE NOTIFIED AT LEAST TWO WORKING DAYS PRIOR TO THE COMMENCEMENT OF WORK OR AS STIPULATED BY THE CODE ENFORCEMENT OFFICIAL HAVING JURISDICTION.
- 9. GRADING OF THE SITE WORK AREA IS TO BE SMOOTH AND CONTINUOUS IN SLOPE AND IS TO FEATHER INTO EXISTING
- 10. ALL EXCAVATIONS FOR THE INSTALLATION OF FOUNDATIONS, UTILITIES, ETC., SHALL BE PROPERLY LAID BACK OR

- BRACED IN ACCORDANCE WITH CORRECT OCCUPATIONAL SAFETY AND HEALTH ADMINISTRATION (OSHA) REQUIREMENTS.
- 11. STRUCTURAL FILLS SUPPORTING PAVEMENTS SHALL BE COMPACTED TO 100% OF MAXIMUM STANDARD PROCTOR DRY
- 12. NEW GRADES NOT IN BUILDING AND DRIVEWAY IMPROVEMENT AREA TO BE ACHIEVED BY FILLING WITH APPROVED
- CLEAN FILL AND COMPACTED TO 95% OF STANDARD PROCTOR DENSITY.
- 13. ALL FILL SHALL BE PLACED IN UNIFORM LIFTS. THE LIFTS THICKNESS SHOULD NOT EXCEED THAT WHICH CAN BE
- 14. ANY FILLS PLACED ON EXISTING SLOPES THAT ARE STEEPER THAN 10 HORIZONTAL TO 1 VERTICAL SHALL BE PROPERLY BENCHED INTO THE EXISTING SLOPE AS DIRECTED BY A GEOTECHNICAL ENGINEER
- THE GRADES WITHIN THE FENCED-IN AREA ARE TO BE ACHIEVED BY COMPACTING CLEAN FILL TO A DENSITY OF 90% OF STANDARD PROCTOR COVERING THE AREA WITH 6 MIL. VISQUENE (1' OVERLAP AT SEAMS) FOR WEED SUPPRESSION, THEN ACHIEVING FINISH GRADE BY ADDING 6" OF 3/4" CRUSHED STONE-NO FINES.
- 16. CONTRACTOR SHALL CLEAN ENTIRE SITE AFTER CONSTRUCTION SO THAT NO PAPERS, TRASH, WEEDS, BRUSH OR ANY OTHER DEPOSITS WILL REMAIN. ALL MATERIALS COLLECTED DURING CLEANING OPERATIONS SHALL BE DISPOSED OF
- 17. ALL TREES AND SHRUBS WHICH ARE NOT IN DIRECT CONFLICT WITH THE IMPROVEMENTS SHALL BE PROTECTED.
- 18. GC TO HIRE PUBLIC & PRIVATE LOCATE SERVICE IN ORDER TO LOCATE AND PROTECT ANY AND ALL SURFACE UTILITIES. DO NOT SCALE OFF THESE PLANS FOR ANY BELOW GRADE UTILITIES.
- 19. THESE PLANS MAY NOT CONTAIN OR REVEAL ALL SUBSURFACE UTILITIES; GC IS RESPONSIBLE OF LOCATING AND
- 20. OWNER FURNISHED MATERIALS, T-MOBILE "THE COMPANY" WILL PROVIDE AND THE CONTRACTOR WILL INSTALL:
- BTS EQUIPMENT FRAME (PLATFORM) AND ICEBRIDGE SHELTER (GROUND BUILD/CO-LOCATE ONLY)
- D. TOWERS, MONOPOLE

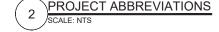

- GENERATORS & LIQUID PROPANE TANK
 ANTENNA STANDARD BRACKETS, FRAMES, AND PIPES FOR MOUNTING.
 ANTENNAS (INSTALLED BY OTHERS)
- TRANSMISSION LINE
- TRANSMISSION LINE JUMPERS
- TRANSMISSION LINE JUMPERS
 TRANSMISSION LINE CONNECTORS WITH WEATHERPROOFING KITS
 TRANSMISSION LINE GROUND KITS
 HANGERS
 HANGERS

- HOISTING GRIPS BTS EQUIPMENT
- 21 CONTRACTOR TO FURNISH AND INSTALL THE FOLLOWING: THE CONTRACTOR IS RESPONSIBLE TO PROVIDE ALL OTHER CONTRACTOR TO PORNISH AND INSTALL HE POLLOWING: THE CONTRACTOR IS RESPONSIBLE TO PROVIDE ALL OTH MATERIALS FOR THE COMPLETE INSTALLATION OF THE SITE INCLUDING, BUT NOT LIMITED TO, SUCH MATERIALS AS FENCING, STRUCTURAL STEEL SUPPORTING SUB-FRAME FOR PLATFORM, ROOFING LABOR AND MATERIALS, GROUNDING RINGS, GROUNDING WIRES, COPPER-CLAD OR XIT OF HEMICAL GROUND RODIGS, BUSS BARS, TRANSFORMERS AND DISCONNECT SWITCHES WHERE APPLICABLE, TEMPORARY ELECTRICAL POWER, CONDUIT, LANDSCAPING COMPOUND STONE, CRANES, CORE DRILLING, SLEEPERS AND RUBBER MATTING, REBAR, CONCRETE CAISSONS, PADS AND/OR AUGER MOUNTS, MISCELLANEOUS FASTENERS, CABLE TRAYS, NON-STANDARD ANTENNA FRAMES AND ALL OTHER MATERIAL AND LABOR REQUIRED TO COMPLETE THE US ACCORDING TO THE DRAWINGS AND SPECIFICATIONS. IT IS THE POSITION OF T-MOBILE TO APPLY FOR PERMITTING AND CONTRACTOR RESPONSIBLE FOR PICKUP AND PAYMENT OF REQUIRED PERMITS.
- 22. T-MOBILE FURNISHED EQUIPMENT SHALL BE PICKED-UP AT THE T-MOBILE WAREHOUSE, NO LATER THAN 48HR AFTER BEING NOTIFIED INSURED, STORED, UNCATED, PROTECTED AND INSTALLED BY THE CONTRACTOR WITH ALL APPURTENCES REQUIRED TO PLACE THE EQUIPMENT IN OPERATION, READY FOR USE. THE CONTRACTOR SHALL BE RESPONSIBLE FOR THE EQUIPMENT AFTER PICKING UP.
- 23. ALL EQUIPMENT FURNISHED AND WORK PERFORMED UNDER THE CONTRACT DOCUMENTS SHALL BE GUARANTEED AGAINST DEFECTS IN MATERIALS OR WORKMANSHIP FOR A PERIOD OF ONE (1) YEAR FROM THE DATE OF FINAL ACCEPTANCE, UNLESS NOTED OTHERWISE. ANY FAILURE OF EQUIPMENT OR WORK DUE TO DEFECTS IN MATERIALS OR WORKMANSHIP SHALL BE CORRECTED BY THE CONTRACTOR AT NO COST TO THE OWNER
- 24. ALL WORK, MATERIAL, AND EQUIPMENT SHALL COMPLY WITH ALL REQUIREMENTS OF THE LATEST EDITIONS AND INTERIM AMENDMENTS OF THE NATIONAL ELECTRICAL CODE (NEC). NATIONAL ELECTRICAL SAFETY CODE, OSHA, AND ALL APPLICABLE FEDERAL, STATE, AND LOCAL LAWS AND ORDINANCES. ALL ELECTRICAL EQUIPMENT PROVIDED UNDER THIS CONTRACT SHALL BE NEW (EXCEPT WHERE OTHERWISE NOTED) AND SHALL COMPLY WITH THE REQUIREMENTS OF THE UNDERWRITERS' LABORATORIES (U.L.) AND BEAR THE U.L. LABEL.





CHECKED BY: RH CHECKED BY: GMS



SITE #: DN06027A DN73XC079 4204 CRESTONE PEAK ST BRIGHTON, CO 80601

SHEET TITLE:

SITE NOTES

SHEET NUMBER:

SP-1

GENERAL NOTES

GENERAL NOTES:

- 1. T-MOBILE OR HIS ARCHITECT/ENGINEER RESERVES THE RIGHT TO REJECT ANY EQUIPMENT OR MATERIALS WHICH, IN HIS OPINION ARE NOT IN COMPLIANCE WITH THE CONTRACT DOCUMENTS, EITHER BEFORE OR AFTER INSTALLATION AND THE EQUIPMENT SHALL BE REPLACED WITH EQUIPMENT CONFORMING TO THE REQUIREMENTS OF THE CONTRACT DOCUMENTS BY THE CONTRACTOR AT NO COST TO THE OWNER OR HIS ARCHITECT/ENGINEER.
- THE CONTRACTOR SHALL SUPPORT, BRACE AND SECURE EXISTING STRUCTURE AS REQUIRED. CONTRACTOR IS SOLELY RESPONSIBLE FOR THE PROTECTION OF ANY EXISTING STRUCTURES DURING CONSTRUCTION. FIELD VERIFY ALL EXISTING DIMENSIONS WHICH AFFECT THE NEW CONSTRUCTION.
- 3. THE CONTRACTOR SHALL NOT ALLOW OR CAUSE ANY OF THE WORK TO BE COVERED UP OR ENCLOSED UNTIL IT HAS BEEN INSPECTED BY THE GOVERNING AUTHORITIES. ANY WORK THAT IS ENCLOSED OR COVERED UP BEFORE SUCH INSPECTION AND TEST SHALL BE UNCOVERED AT THE CONTRACTOR'S EXPENSE; AFTER IT HAS BEEN INSPECTED, THE CONTRACTOR SHALL RESTORE THE WORK TO ITS ORIGINAL CONDITION AT HIS OWN EXPENSE
- 4. ALL EXISTING UTILITIES, FACILITIES, CONDITIONS, AND THEIR DIMENSIONS SHOWN ON PLANS HAVE BEEN PLOTTED FROM AVAILABLE RECORDS. THE ARCHITECT/ENGINEER AND OWNER (T-MOBILE) ASSUME NO RESPONSIBILITY WHATEVER AS TO THE SFOFICIENCY OR ACCURACY OF THE INFORMATION SHOWN ON THE PLANS OR THE MANNER OF THEIR REMOVAL OR ADJUSTMENT. CONTRACTOR SHALL BE RESPONSIBLE FOR DETERMINING EXACT LOCATION OF ALL SAID UTILITIES AND FACILITIES PRIOR TO START OF CONSTRUCTION. CONTRACTOR SHALL ALSO OBTAIN FROM EACH UTILITY COMPANY DETAILED INFORMATION RELATIVE TO WORKING SCHEDULES AND METHODS OF REMOVING OR ADJUSTING AFFECTED UTILITIES.
- 5. CONTRACTOR SHALL FIELD VERIFY ALL EXISTING UTILITIES BOTH HORIZONTALLY AND VERTICALLY PRIOR TO START OF CONSTRUCTION. ANY DISCREPANCIES OR DOUBTS AS TO THE INTERPRETATION OF PLANS SHOULD BE IMMEDIATELY REPORTED TO THE PROJECT MANAGER FOR RESOLUTION AND INSTRUCTION, AND NO FURTHER WORK SHALL BE PERFORMED UNTIL DISCREPANCY IS CHECKED AND CORRECTED BY THE ARCHITECT/ENGINEER. FAILURE TO SECURE SUCH INSTRUCTION MEANS CONTRACTOR WILL HAVE WORKED AT HIS OWN RISK AND EXPENSE
- CONTRACTORS SHALL CLEAN ENTIRE SITE EACH DAY AFTER CONSTRUCTION SUCH
 THAT NO PAPERS, TRASH, DEBRIS, WEEDS, BRUSH, OR ANY OTHER DEPOSITS REMAIN.
 ALL MATERIALS COLLECTED DURING CLEANING OPERATIONS SHALL BE PROPERLY
 DISPOSED OF OFF-SITE BY THE CONTRACTOR.
- ALL SITE WORK SHALL BE CAREFULLY COORDINATED BY THE CONTRACTOR WITH LOCAL GAS, ELECTRIC, TELEPHONE, AND ANY OTHER UTILITY COMPANIES HAVING JURISDICTION OVER THIS LOCATION.
- 8. DURING CONSTRUCTION, THE CONTRACTOR SHALL AT ALL TIMES MAINTAIN THE UTILITIES OF THE BUILDING/SITE WITHOUT INTERRUPTION. SHOULD IT BE NECESSARY TO INTERRUPT ANY SERVICE OR UTILITY, THE CONTRACTOR SHALL SECURE PERMISSION IN WRITING FROM THE BUILDING/PROPERTY OWNER FOR SUCH INTERRUPTION, AT LEAST 72 HOURS IN ADVANCE. ANY INTERRUPTION SHALL BE MADE WITH A MINIMUM AMOUNT OF INCONVENIENCE TO THE BUILDING/PROPERTY OWNER AND ANY SUCH SHUTDOWN TIME SHALL BE COORDINATED WITH THE BUILDING/PROPERTY OWNER.
- CONTRACTOR SHALL MINIMIZE DISTURBANCE TO EXISTING SITE DURING CONSTRUCTION. EROSION CONTROL MEASURES, IF REQUIRED DURING CONSTRUCTION.
- CONTRACTOR SHALL SUBMIT AT THE END OF THE PROJECT A COMPLETE SET OF AS BUILT DRAWINGS TO T-MOBILE'S PROJECT ENGINEER.
- 11. GC WILL NOT START THE CONSTRUCTION UNTIL AFTER THEY RECEIVE THE PRE CON PACKAGE AND HAVE A PRE CON WALK WITH THE PROJECT MANAGER.

DIVISION 2 - SITE WORK:

- THE CONTRACTOR SHALL CALL UTILITIES PRIOR TO THE START OF CONSTRUCTION.
 ALL EXISTING ACTIVE SEWER, WATER, GAS, ELECTRIC, AND OTHER UTILITIES
 WHERE ENCOUNTERED IN THE WORK SHALL BE PROTECTED AT ALL TIMES, AND
 WHERE REQUIRED FOR THE PROPER EXECUTION OF THE WORK, SHALL BE
 RELOCATED AS DIRECTED BY THE PROJECT MANAGER. EXTREME CAUTION SHOULD
 BE USED BY THE CONTRACTOR WHEN EXCAVATING OR PIER DRILLING AROUND OR
 NEAR UTILITIES. CONTRACTOR SHALL PROVIDE SAFETY TRAINING FOR THE
 WORKING CREW. THIS WILL INCLUDE BUT NOT LIMITED TO:
 - A. FALL PROTECTION
 - B. CONFINED SPACE
 - C. ELECTRICAL SAFETY
 - D. TRENCHING AND EXCAVATION
- REMOVE FROM SITE/OWNER'S PROPERTY ALL WASTE MATERIALS, UNUSED EXCAVATED MATERIAL INCLUDING MATERIAL CLASSIFIED UNSATISFACTORY, CONTAMINATED OR DANGEROUS TRASH AND DEBRIS, AND DISPOSE OF IN A LEGAL MANNER
- ALL EXISTING INACTIVE SEWER, WATER, GAS, ELECTRIC AND OTHER UTILITIES, WHICH INTERFERE WITH THE EXECUTION OF THE WORK, SHALL BE REMOVED AND/OR CAPPED, PLUGGED OR OTHERWISE DISCONTINUED AT POINTS WHICH WILL NOT INTERFERE WITH THE EXECUTION OF THE WORK, SUBJECT TO THE APPROVAL OF ENGINEERING.

- THE AREAS OF THE OWNERS PROPERTY DISTURBED BY THE WORK AND NOT COVERED BY THE BUILDING OR DRIVEWAY, SHALL BE GRADED TO A UNIFORM SLOPE, FERTILIZED, SEEDED, AND COVERED WITH MULCH
- CONTRACTOR SHALL MINIMIZE DISTURBANCE TO EXISTING SITE DURING CONSTRUCTION. EROSION CONTROL MEASURES, AS REQUIRED DURING CONSTRUCTION.

CONTRACTOR IS RESPONSIBLE FOR LAYOUT AND CONSTRUCTION STAKING.
CONTRACTOR SHALL ESTABLISH GRADE AND LINE STAKES PRIOR TO CONSTRUCTION

CONCORDIA DOES NOT GUARANTEE OR WARRANT THAT THE AFOREMENTIONED EASEMENTS ARE SFOFICIENT FOR CONSTRUCTION TRAFFIC. GC SHALL CONSULT WITH A T-MOBILE REPRESENTATIVE AND LANDLORD WITH EXACT LOGISTICS TO FACILITATE CONTRACTIBILITY OF THE SITE AND DELIVERY OF CRITICAL MATERIALS SUCH AS THE TOWER, STEEL, CONCRETE AND CRANES TO THE PROPOSED LEASE AREA. GC SHALL RESTORE SITE TO ORIGINAL CONDITIONS AND REPLACE ANY AND ALL DISTURBED TREES OR LANDSCAPING.

CONCORDIA IS NOT RESPONSIBLE FOR THE MAINTENANCE AND/OR OPERATIONAL FEASIBILITY.

SCOPE OF WORK FOR THESE PLANS DOES NOT INVOLVE VALUE ENGINEERING AS WELL AS MAINTAINABILITY OPERATIONS OF THE SITE, ACCESS OR UTILITIES.

DIVISION 3 - CONCRETE:

- MINIMUM ALLOWABLE CONCRETE COMPRESSIVE STRENGTH SHALL BE
 4000 PSI AT 28 DAYS WHEN TESTED IN ACCORDANCE WITH THE
 AMERICAN SOCIETY FOR TESTING AND MATERIALS METHODS STANDARDS ASTM
 C172. ASTM C31 AND ASTM C39 UNLESS OTHERWISE NOTED.
- CONCRETE FOR ALL FOUNDATIONS: 540 LBS PER CUBIC YARD OF CONCRETE MINIMUM CEMENT CONTENT FOR 1-INCH MAXIMUM SIZE AGGREGATE, SLUMP RANGE 3 INCHES TO 5 INCHES, TOTAL AIR CONTENT 4 PERCENT TO 7 PERCENT BY VOLUME. AIR ENTRAINING ADMIXTURE REQUIRED TO CONTROL TOTAL AIR CONTENT, WATER REDUCING ADMIXTURE PERMITTED TO OBTAIN SLUMP OVER 3-INCHES.
- ALL CONCRETE CONSTRUCTION SHALL MEET THE REQUIREMENTS OF THE LATEST EDITION OF THE AMERICAN CONCRETE INSTITUTE (ACI 318) BUILDING CODE REQUIREMENTS FOR REINFORCED CONCRETE AND (ACI 301) STANDARD SPECIFICATION FOR STRUCTURAL CONCRETE.
- REBARS SHALL BE ASTM A-615 DEFORMED TYPE WITH MINIMUM YIELD STRENGTH OF 60,000 PSI (40,000 PSI GRADE MAY BE USED FOR TIES & STIRRUPS).

WELDED WIRE FABRIC SHALL CONFORM TO ASTM A-185.

- 5. DETAILING SHALL BE IN ACCORDANCE WITH MANUAL OF STANDARD PRACTICE OF DETAILING REINFORCED CONCRETE STRUCTURES (ACI STD-315 LATEST EDITION).
- 6. CHAMFER ALL EXPOSED EDGES OF CONCRETE 3/4".UNLESS OTHERWISE NOTED.
- REINFORCING STEEL SHALL BE ACCURATELY PLACED AND ADEQUATELY SECURED IN POSITION. LOCATION OF REINFORCEMENT SHALL BE INDICATED ON THE DRAWINGS. THE FOLLOWING MINIMUM COVER (INCHES) FOR REINFORCEMENT SHALL BE PROVIDED, EXCEPT AS NOTED ON DRAWINGS.

MINIMUM COVER (INCHES)

CAST AGAINST AND PERMANENTLY EXPOSED TO EARTH ... 3"

EXPOSED TO EARTH OR WEATHER:

#6 THROUGH #18 ... 2"

#5 BAR AND SMALLER ... 1-1/2"

- 8. TESTS
- CONCRETE MATERIALS AND OPERATIONS SHALL BE TESTED AND INSPECTED BY THE ENGINEER AS THE WORK PROGRESSES. FAILURE TO DETECT ANY DEFECTIVE WORK OR MATERIAL SHALL NOT IN ANY WAY PREVENT LATER REJECTION WHEN SUCH DEFECT IS DISCOVERED NOR SHALL IT OBLIGATE THE ENGINEER FOR FINAL ACCEPTANCE.
- A. FIVE CONCRETE TEST CYLINDERS SHALL BE TAKEN OF THE TOWER PIER FOUNDATION.

 TWO SHALL BE TESTED @ THREE DAYS, TWO @ TWENTY-EIGHT DAYS. THE FIFTH

 CYLINDER SHALL BE KEPT SEPARATELY. IF REQUIRED TO BE USED IN THE FUTURE.
- B. ONE ADDITIONAL TEST CYLINDER SHALL BE TAKEN DURING COLD WEATHER AND CURED ON SITE UNDER SAME CONDITIONS AS CONCRETE IT REPRESENTS.
- C. ONE SLUMP TEST SHALL BE TAKEN FOR EACH SET OF TEST CYLINDERS TAKEN.
- 9. PLACING CONCRETE
- A. THE ENGINEER SHALL BE NOTIFIED NOT LESS THAT 24 HOURS IN ADVANCE OF CONCRETE PLACEMENT, UNLESS INSPECTION IS WAIVED IN EACH CASE, PLACING OF CONCRETE SHALL BE PERFORMED ONLY IN THE PRESENCE OF THE ENGINEER. CONCRETE SHALL NOT BE PLACED UNTIL ALL FORMWORK, EMBEDDED PARTS, STEEL REINFORCEMENT, FOUNDATION SURFACES AND JOINTS INVOLVED IN THE PLACING HAVE BEEN APPROVED, AND UNTIL FACILITIES ACCEPTABLE TO THE T-MOBILE REPRESENTATIVE HAVE BEEN PROVIDED AND MADE READY FOR ACCOMPLISHMENT OF THE WORK AS SPECIFIED. CONCRETE MAY NOT BE ORDERED FOR PLACEMENT UNTIL ALL ITEMS HAVE BEEN APPROVED AND T-MOBILE HAS PERFORMED A FINAL INSPECTION AND GIVEN APPROVAL TO START PLACEMENT IN WRITING.
- B. PLACEMENT OF CONCRETE SHALL BE IN ACCORDANCE WITH ACI 301.

- 10. PROTECTION
- A. IMMEDIATELY AFTER PLACEMENT, THE CONTRACTOR SHALL PROTECT THE CONCRETE FROM PREMATURE DRYING, EXCESSIVELY HOT OR COLD TEMPERATURES, AND MECHANICAL INJURY, PINISHED WORK SHALL BE PROTECTED.
- B. CONCRETE SHALL BE MAINTAINED WITH MINIMAL MOISTURE LOSS AT RELATIVELY

 CONSTANT TEMPERATURE FOR A PERIOD NECESSARY FOR HYDRATION OF CEMENT AND

 HARDENING OF CONCRETE
- C. ALL CONCRETE SHALL BE WATER CURED BY CONTINUOUS (NOT PERIODIC) FINE
 MIST SPRAYING OR SPRINKLING ALL EXPOSED SURFACES. WATER SHALL BE CLEAN
 AND FREE FROM ACID, ALKALI, SALTS, OIL SEDIMENT, AND ORGANIC MATTER.
 SUCCESSFUL CURING SHALL BE OBTAINED BY USE OF AN AMPLE WATER SUPPLY
 UNDER PRESSURE IN PIPES, WITH ALL NECESSARY APPLIANCES OF SPRINKLERS, AND
 SPRAYING DEVICES

ELECTRICAL NOTES:

1. ELECTRICAL DESIGN SHALL BE PERFORMED BY ELECTRICAL CONTRACTOR. STRUCTRUAL DESIGN SHALL BE PERFORMED BY GENERAL CONTRACTOR. ELECTRICAL CONTRACTOR SHALL ENSURE THAT ALL WORK COMPLIES WITH ALL APPLICABLE LOCAL AND STATE CODES AND NATIONAL ELECTRICAL CODE

2. ALL SUGGESTED ELECTRICAL ELEMENTS (SUCH AS BREAKER SIZES, WIRE SIZES, CONDUITS SIZES ARE FOR ZONING PURPOSES ONLY. IT IS THE RESPONSIBILITY TO OF THE ELECTRICAL CONTRACTOR TO CONFIRM COMPLIANCE WITH LOCAL ELECTRICAL CODES AND PASS ALL APPLICABLE AND NECESSARY INSPECTIONS. IN SOME EVENTS, IT MAY BE NECESSARY TO PERFORM AN ELECTRICAL LOAD STUDY TO VERIFY THE CAPACITY OF THE EXISTING SERVICE. THIS IS NOT THE RESPONSIBILITY OF CONCORDIA. IT IS THE RESPONSIBILITY OF THE ELECTRICAL CONTRACTOR.

3. CONTRACTOR SHALL FIELD LOCATE ALL BELOW GRADE GROUND LINES AND UTILITY LINES PRIOR TO CONSTRUCTION. CONTRACTOR IS RESPONSIBLE FOR RELOCATION OF ALL UTILITIES AND GROUND LINES THAT MAY BECOME DISTURBED OR CONFLICTING IN THE COURSE OF CONSTRUCTION.

DIVISION 5:

STRUCTURAL STEEL

- ALL DETAILING, FABRICATION AND ERECTION OF STRUCTURAL STEEL SHALL CONFORM
 TO AISC SPECIFICATIONS AND CODES
- 2. PROVIDE STRUCTURAL STEEL AS FOLLOWS:

 WIDE FLANGE SHAPES
 ASTM A992 GR50

 STEEL PIPE
 ASTM A53 GR B

 STEEL TUBE (HSS)
 ASTM A1085 OR A500 GR. C

 ANCHOR RODS (THREADED RODS)
 ASTM F1554 GR. 50 (U.N.O.)

 ALL OTHER STEEL
 ASTM A36

 ASSUMED EXISTING STEEL GRADE
 ASTM A36 (U.N.O.)

- 3. ALL STRUCTURAL STEEL TO BE STRAIGHT AND FREE OT TWIST. COLUMN BEARING ENDS TO BE TRUE AND SQUARE. ALL COLUMNS TO BE PLUMB AND LEVEL BEARING
- ALL BOLTS, NUTS AND WASHERS SHALL CONFORM TO THE REQUIREMENTS OF ASTM A325 HOT-DIP GALVANIZED.
- ALL CONNECTIONS, UNLESS INDICATED OTHERWISE, SHALL BE SIMPLE SHEAR CONNECTIONS UTILIZING A MIN. OF TWO 3/4" DIAMETER A325 HIGH STRENGTH BOLTS IN BEARING TYPE CONNECTIONS. ALL JOINTS SHALL BE SNUG-TIGHTENED.
- 6. UNLESS NOTED ON THE CONTRACT DRAWINGS, ALL CONNECTIONS SHALL BE DESIGNED AND DETAILED BY THE FABRICATOR, USING RATIONAL ENGINEERING DESIGN AND STANDARD PRACTICE IN ACCORDANCE WITH THE REQUIREMENTS OF THE CONTRACT DOCUMENTS FOR 100% OF THE UNIFORM LOAD SHOWN IN THE MAXIMUM TOTAL UNIFORM LOAD TABLES 3-6 THRU 3-9 OF THE AJICS STEEL CONSTRUCTION MANUAL FOR THE SPAN SHOWN ON THE DRAWING.
- 7. ALL WELDING ELECTRODES SHALL BE E70XX.
- ALL WELDING WORK SHALL CONFORM TO THE AWS D1.1 STRUCTURAL WELDING CODE, LATEST EDITION, AND SHALL BE PERFORMED BY AWS CERTIFIED WELDERS.
- THE CONTRACTOR SHALL SUBMIT DETAILED, ENGINEERED, COORDINATED, AND CHECKED SHOP DRAWINGS FOR ALL STRUCTURAL STEEL TO THE ENGINEER TO REVIEW FOR COMPLIANCE WITH THE DESIGN INTENT PRIOR TO THE START OF FABRICATION AND/OR ERECTION.
- MINIMUM FILLET WELD SIZE SHALL COMPLY WITH THE AISC REQUIREMENTS, BUT SHALL NOT BE LESS THAN 3/16 INCH, UNLESS NOTED OTHERWISE.
- 11. ALL PARTIAL PENETRATION WELD SIZES INDICATED DESIGNATE EFFECTIVE THROAT SIZE UNITESS NOTED OTHERWISE.
- 12. ALL BEAMS SHALL BE FABRICATED WITH THE NATURAL CAMBER UP
- 13. THE CONTRACTOR SHALL BE RESPONSIBLE FOR THE CONTROL OF ALL ERECTION PROCEDURES AND SEQUENCES, ESPECIALLY WITH RELATION TO TEMPERATURE DIFFERENTIAL, ERECTION TOLERANCES, AND WITH RESPECT TO STRUCTURAL STEEL FRAMING INTO BEAMS, COLUMNS, OR WALLS.
- 14. AFTER FABRICATION, ALL STEEL SHALL BE CLEANED OF ALL RUST, LOOSE MILL SCALE AND OTHER FOREIGN MATERIALS AND SHALL BE HOT-DIP GALVANIZED PER ASTM A12:
- 15. THERE SHALL BE NO FIELD CUTTING OF STRUCTURAL STEEL MEMBERS, FOR THE WORK OF OTHER TRADES, WITHOUT THE PRIOR APPROVAL OF THE ARCHITECTIENGINEER.
- 16. ALL ADDITIONAL STEEL REQUIRED BY THE CONTRACTOR FOR ERECTION PURPOSES AND SITE ACCESS OF STOCKPILED MATERIALS SHALL BE PROVIDED AT NO COST TO THE OWNER. ALL SUCH ADDITIONAL STEEL SHALL BE REMOVED BY THE CONTRACTOR UNLESS APPROVED BY THE OWNER IN WRITING.
- ALL PLAN DIMENSIONS ARE TO STRUCTURAL STEEL MEMBER CENTERLINES, EXCEPT FOR CHANNELS AND ANGLES. CHANNEL AND ANGLE DIMENSIONS ARE TO THE BACK FACE OF THE WEB.

NON-STRUCTURAL COMPONENT ANCHORAGE NOTES:

MECHANICAL, PLUMBING, COMMUNICATION, AND ELECTRICAL COMPONENTS SHALL BE ANCHORED AND INSTALLED PER THE DETAILS ON THE CONSTRUCTION DOCUMENTS. WHERE NO DETAIL IS INDICATED, THE FOLLOWING COMPONENTS SHALL BE ANCHORED AND BRACED TO RESIST THE FORCE AND DISPLACEMENT REQUIREMENTS PRESCRIBED IN THE ASCE 7-16 CHAPTER 13, 26, 29 AND 30 FOR THE LOADS LISTED ABOVE EXCEPT, MECHANICAL AND ELECTRICAL EQUIPMENT IN SEISMIC DESIGN CATEGORY "B" ARE EXEMPT FROM REQUIREMENTS OF CHAPTER 13.

- PERMANENT EQUIPMENT AND COMPONENTS
- 2. TEMPORARY OR MOVABLE EQUIPMENT THAT IS PERMANENTLY ATTACHED (E.G. HARDWIRED) TO THE BUILDING UTILITY SERVICES SUCH AS ELECTRICITY, GAS, OR WATER.
- MOVABLE EQUIPMENT WHICH IS STATIONED IN ONE PLACE FOR MORE THAN 8 HOURS AND HEAVIER THAN 400 POUNDS ARE REQUIRED TO BE ANCHORED WITH TEMPORARY ATTACHMENTS.

THE FOLLOWING MECHANICAL AND ELECTRICAL COMPONENTS SHALL BE POSITIVELY ATTACHED TO THE STRUCTURE, BUT THE ATTACHMENT NEED NOT BE DETAILED ON THE INSTALLATION SHOP DRAWINGS.

- COMPONENTS WEIGHING LESS THAN 400 POUNDS AND HAVE A CENTER OF MASS LOCATED 4
 FEET OR LESS ABOVE THE ADJACENT FLOOR OR ROOF LEVEL THAT DIRECTLY SUPPORT THE
 COMPONENT.
- . COMPONENTS WEIGHING LESS THAN 20 POUNDS, AND IN THE CASE OF DISTRIBUTED SYSTEMS, LESS THAN 5 POUNDS PER FOOT, WHICH ARE SUSPENDED FROM A ROOF OR FLOOR OR HUNG FROM A WAII.

FOR THOSE ELEMENTS THAT DO NOT REQUIRE DETAILS ON THE APPROVED SHOP DRAWINGS, THE INSTALLATION SHALL BE SUBJECT TO THE APPROVAL OF THE STRUCTURAL ENGINEER OF RECORD. THE OWNER'S FIELD INSPECTOR SHALL VERIFY THAT ALL COMPONENTS AND EQUIPMENT HAVE BEEN ANCHORED IN ACCORDANCE WITH ABOVE REQUIREMENTS.




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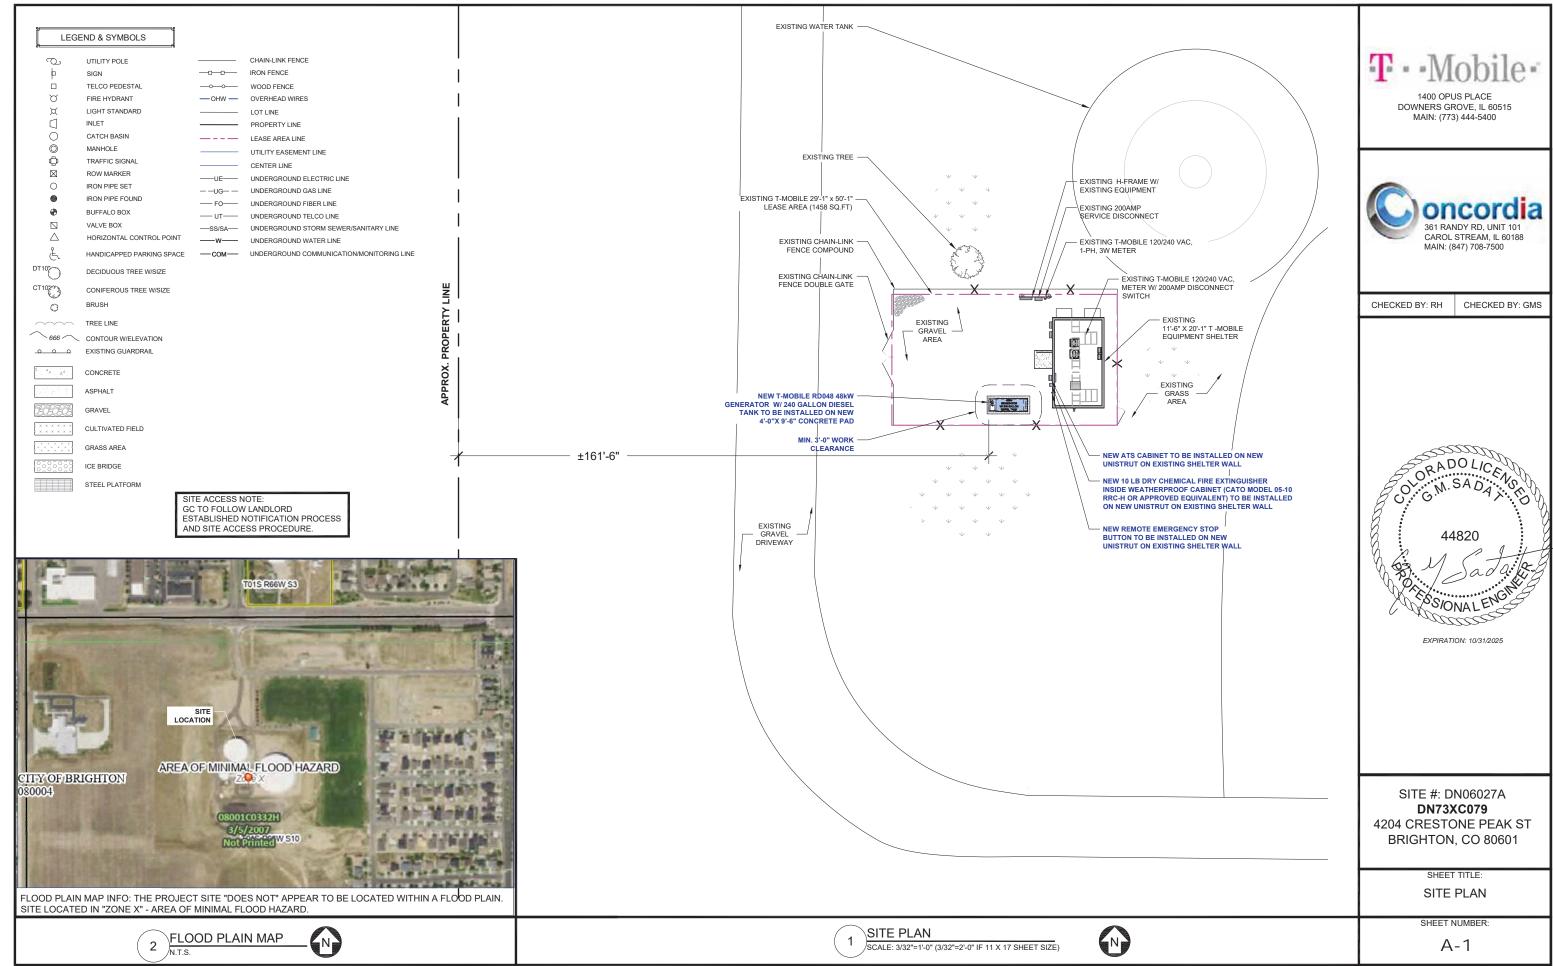



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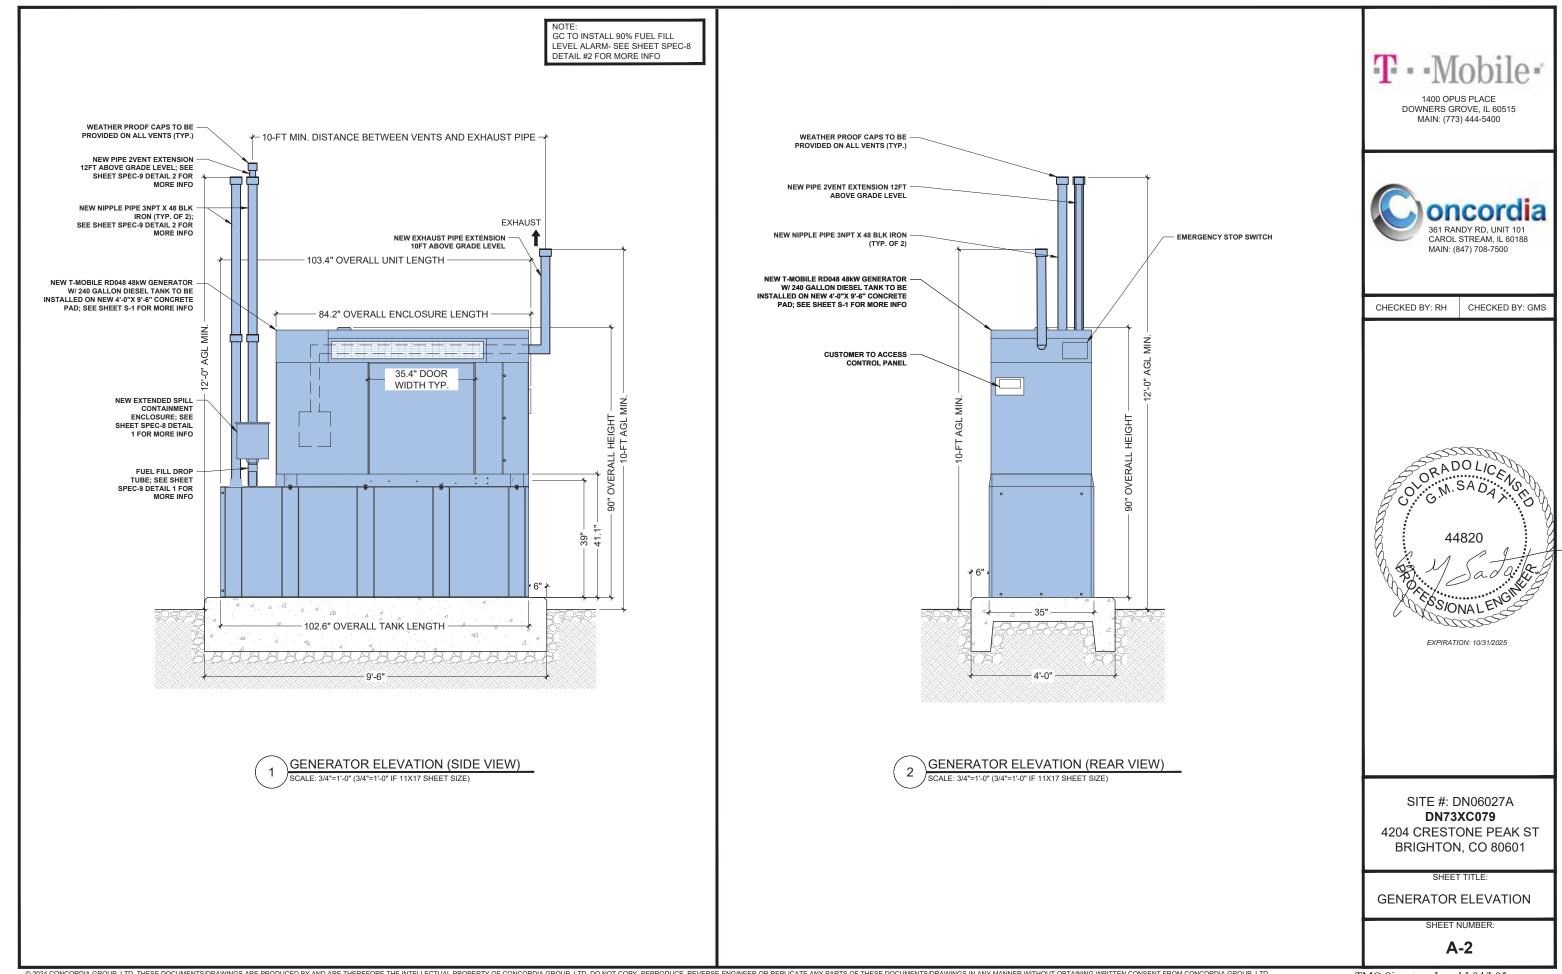
SHEET TITLE:
GENERAL NOTES
& SPECIFICATIONS

SHEET NUMBER:

SP-2

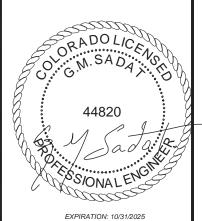



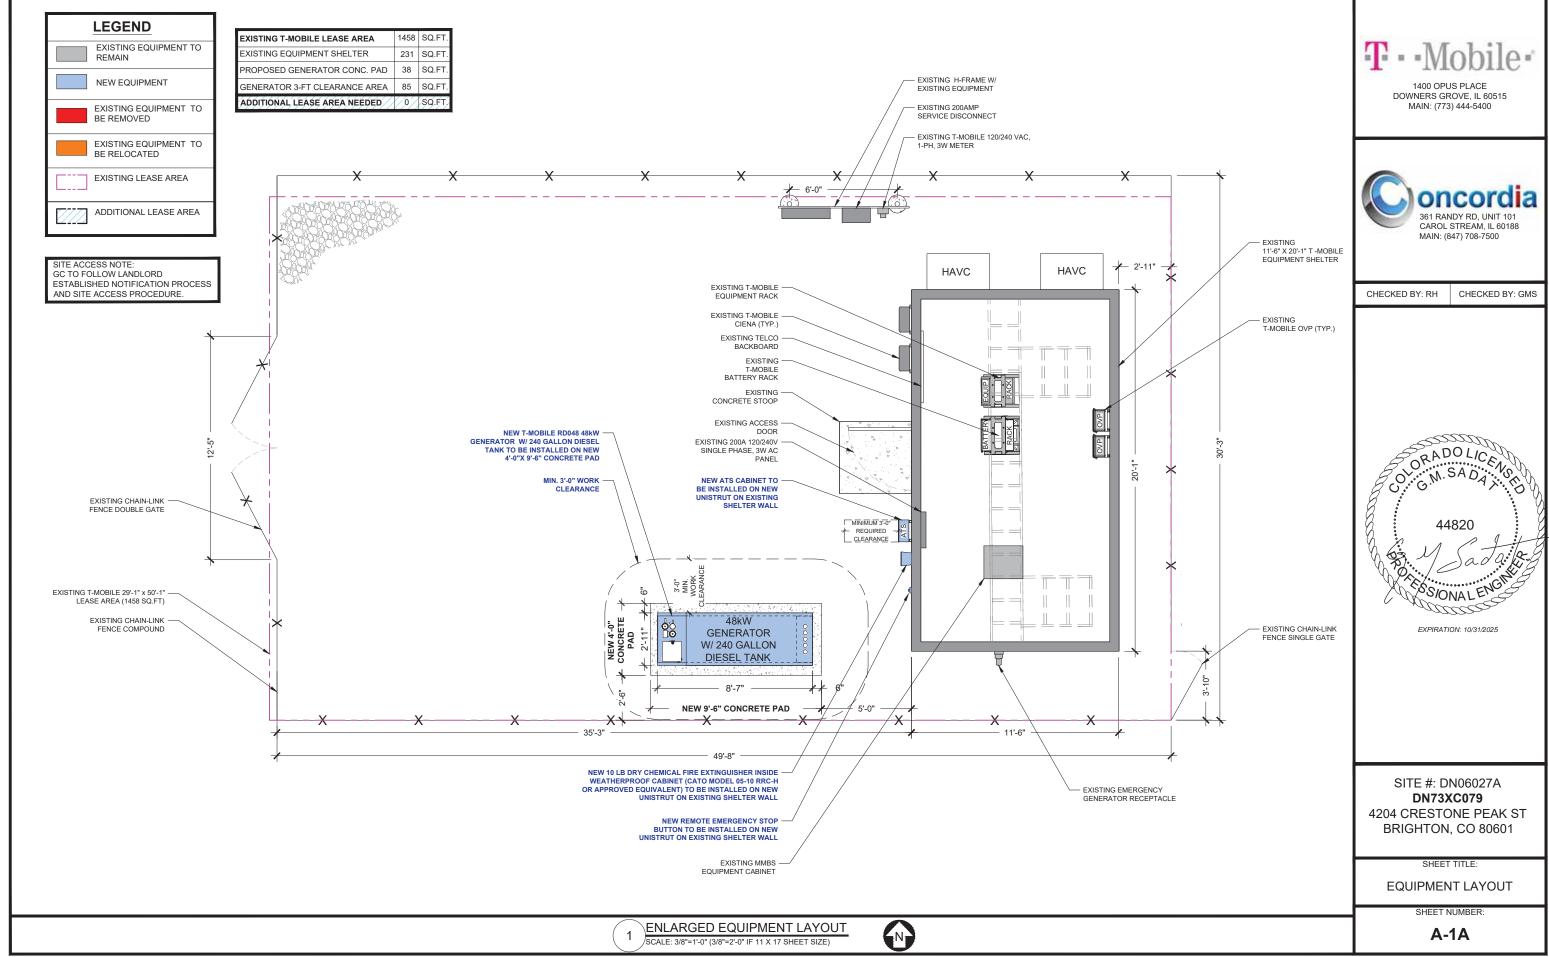

SIGNAGE REQUIREMENTS:

- 1.STORAGE CONTAINER MUST HAVE A DATAPLATE. (PROVIDED BY TANK MANUFACTURER DURING TANK FABRICATION)
 NFPA 58:52.8.3
- 2. STORAGE CONTAINER MUST BE MARKED DESCRIBING THE CONTENETS (PROPANE OR LIQUEFIED PETROLEUM GAS) AND A STATEMENT OF THE HAZARD (FLAMMABLE). NFPA 1:80.1.13 & IFC 2:703.5
- 3. STORAGE CONTAINER MUST BE MARKED WITH HAZMAT ID. (CERTAIN ENTRANCES TO STORAGE OR DISPENSING AREAS MAY ALSO REQUIRE HAZMAT ID MARKING)
 NFPA 1:60.1.13, NFPA 704:1.3 & IFC 2703.5
- 4. NO SMOKING SIGNS MUST BE POSTED IN AREAS OR SITES WHERE FLAMMABLE GASES ARE USED OR STORED. NO SMOKING OR OPEN FLAMES WITHIN 25-FT OF POINT OF TRANSFER. NFPA 1:60.1.13, IFC: 3807.2, IFC: 2703.7 & NFPA 58:7.2.3.2 (B)
- 5. THE MAXIMUM PERMITTED PERCENTAGE (%) OF TANK CAPACITY MUST BE MARKED EITHER ON THE DATAPILATE OR ADJACENT TO THE FIXED MAXIMUM LIQUID LEVEL GAUGE. NFPA 58:5.75.4







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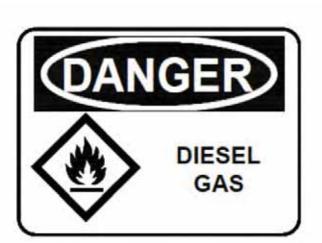
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1 SIGNAGE REQUIREMENTS

N.T.S.

2 DIESEL SIGN

3 FLAMMABLE SIGN



DIESEL





44820

AVENUE DE LA COMPANION DE LA COMPANION

SITE #: DN06027A DN73XC079 4204 CRESTONE PEAK ST BRIGHTON, CO 80601

SHEET TITLE:

SIGNAGE

SHEET NUMBER:

A-3

HAZARD LEVEL INDICATOR SIGN

6 NO SMOKING SIGN

NOTE

1. BOLTS CAN BE INSTALLED 3 DAYS AFTER POURING CONCRETE PROVIDED THE KWIK BOLTS ARE ONLY TIGHTENED TO A SNUG TIGHT CONDITION. 2. APPLY "HILTI" HIT-RE 500-SD EPOXY TO ALL GAPS TO PREVENT

WATER/MOISTURE BUILD-UP. 3. PROVIDE 5 ANCHOR BOLTS PER EACH SIDE OF THE TANK BASE PER MANUFACTURER'S RECOMMENDATIONS.

GENERATOR CONNECTION DESIGN CRITERIA:

1. GENERATOR ANCHORS ARE DESIGNED TO MEET THE INTERNATIONAL BUILDING CODE 2018 CRITERIA FOR WIND SPEED.

1.0

2. WIND PARAMETERS:

SURVIVAL WIND VELOCITY PER ASCE7-10

EQUIVALENT WIND VELOCITY PER ASCE7-05

WIND EXPOSURE WIND RISK CATEGORY WIND IMPORTANCE FACTOR CONCRETE PAD CONSTRUCTION NOTES

CONCRETE SHALL HAVE A MINIMUM COMPRESSIVE STRENGTH OF 5,000 PSI.

CONCRETE SLUMP: 2" TO 4".
AIR ENTRAINMENT: 5% TO 7%

REINFORCED CONCRETE CONSTRUCTION AND MATERIALS SHALL BE IN ACCORDANCE WITH ACI STANDARDS 318.

MINIMUM CLEAR CONCRETE COVER FOR REBAR IS 1 1/2".

REINFORCING MATERIAL SHALL BE IN ACCORDANCE WITH ASTM A615.

ALL REBARS SHALL BE SECURELY WIRE TIED TO PREVENT DISPLACEMENT DURING POURING OF CONCRETE.


CONCRETE VOLUME: 1.17 CUBIC YARDS

CONCRETE PAD AND EMBEDMENT TOLERANCES

CONCRETE DIMENSIONS: PLUS OR MINUS 1/4".

REINFORCING STEEL PLACEMENT: PLUS OR MINUS 1/4" INCLUDING CONCRETE COVER.

 FOUNDATION WAS DESIGNED BY ASSUMING ALLOWABLE SOIL BEARING CAPACITY OF 1,500 PSF.
 THE SOIL UNDERNEATH THE CONCRETE PAD MUST BE FREE OF ORGANIC MATTER OR OTHER DELETERIOUS SUBSTANCES, AND SHOULD BE LEVELED AND COMPACTED TO 90% MODIFIED PROCTOR DENSITY BEFORE PLACING THE FOUNDATION. PAD SHALL BE INSTALLED LEVEL TO WITHIN +/- 1/8".

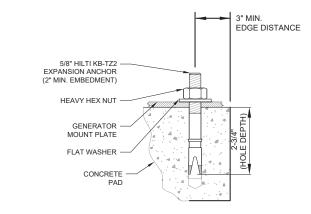





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EXPIRATION: 10/31/2025

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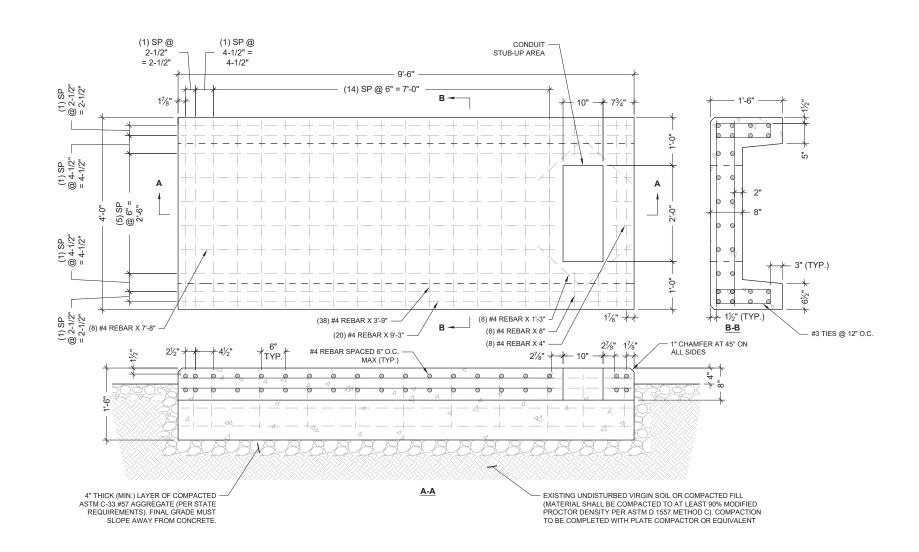
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SHEET TITLE:

CONCRETE PAD DETAILS

S-1

SHEET NUMBER:



CONCRETE PAD DETAIL

SCALE: 1"=1'-0" (1"=2'-0" IF 11 X 17 SHEET SIZE)

IMPORTANT NOTES:


- 1. GC TO ORDER UTILITY LOCATE SERVICE IN ORDER TO LOCATE AND PROTECT ANY AND ALL SURFACE UTILITIES ENCOUNTERED. DO NOT SCALE OFF THESE PLANS FOR ANY BELOW GRADE UTILITIES.
- 2. THESE PLANS MAY NOT CONTAIN OR REVEAL ALL SUBSURFACE UTILITIES; GC IS RESPONSIBLE OF LOCATING AND PROTECTING ALL UTILITIES DURING CONSTRUCTION.
- 3. GC WILL NOT START CONSTRUCTION UNTIL AFTER THEY RECEIVE THE PRE CON PACKAGE AND HAVE A PRE CON WALK WITH THE CLIENT PM
- 4. ALL UNISTRUT, FASTENERS HARDWARE, ETC; ARE TO BE EITHER HOT-DIPPED GAI VANIZED OR STAINLESS STEEL, GENERAL CONTRACTOR SHALL NOT USE ZINC-PLATED OR PRE-GALVANIZED
- 5. WIRE SIZES SHOWN ARE ESTIMATED MINIMUMS. IT IS THE ELECTRICAL CONTRACTOR'S RESPONSIBILITY TO IDENTIFY AND COMPLY WITH THE APPLICABLE LOCAL ELECTRICAL AND BUILDING CODES IN ADDITION TO NEC 2008 AND FOLLOW WHICHEVER IS MORE CONSERVATIVE. CONTRACTOR SHALL ESTIMATE PHASE CONDUCTOR SIZE & UTILIZE THE APPROPRIATE WIRE SIZE AND TYPE ASSUMING A 3% VOLTAGE DROP CONTRACTOR TO CONFIRM WITH LOCAL ELECTRICAL INSPECTOR PRIOR TO CONSTRUCTION. NOTIFY ENGINEER OF DISCREPANCIES PRIOR TO CONSTRUCTION START.
- 6. POWER ROUTE TO BE CONFIRMED WITH T-MOBILE PRIOR TO CONSTRUCTION START.
- 7. GC TO HAND DIG ALL NEW TRENCHES INSIDE COMPOUND.

E ELECTRIC CONDUIT

T — ALARM CABLE

LEGEND

--UE-- UNDERGROUND ELECTRIC CONDUIT

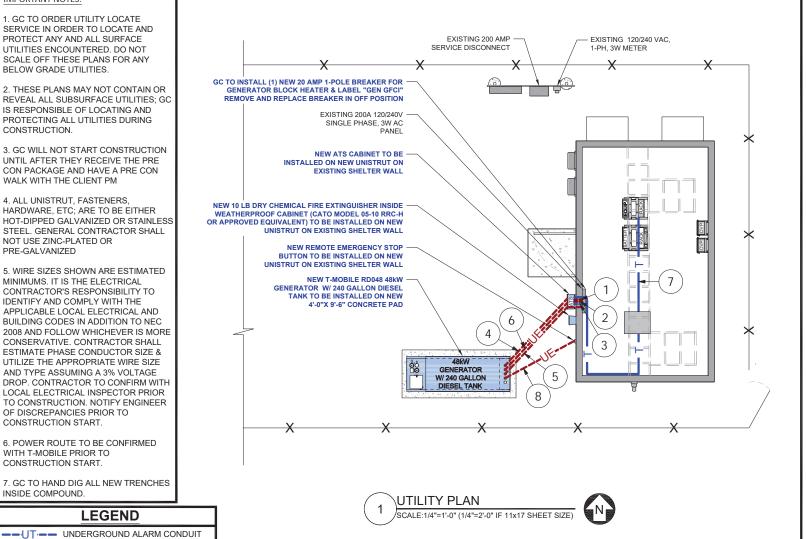


	<u>UTILITY LEGEND</u>												
NO.	FROM	то	WIRE QTY. & TYPE	GROUND (CU WIRE)	CONDUIT SIZE	FUNCTION	APPROXIMATE CONDUIT LENGTH						
1	EXISTING 120/240 VAC, 1Ø, 3W METER	ATS	(3) 3/0	(1) #6	2" RIGID RMC (ABOVE GROUND), UNDERGROUND SCH. 40 GREY PVC	NORMAL POWER FEEDER TO ATS	INTERCEPT AND UTILIZE EXISTING BETWEEN METER AND AC PANEL						
2	ATS	AC PANEL	(3) 3/0	(1) #6	2" RIGID RMC (ABOVE GROUND), UNDERGROUND SCH. 40 GREY PVC	POWER FEEDER TO PPC	±6'						
3	ATS	AC PANEL	(5) #18 TYPE TC WIRES	N/A	1" RIGID RMC (ABOVE GROUND), UNDERGROUND SCH. 40 GREY PVC	ALARM CIRCUIT	±6'						
4	GENERATOR	ATS	(3) 3/0	(1) #6	2" RIGID RMC (ABOVE GROUND), UNDERGROUND SCH. 40 GREY PVC	EMERGENCY POWER FEEDER TO ATS	±25'						
5	GENERATOR	AC PANEL	(2) #12	(1) #12	1" RIGID RMC (ABOVE GROUND), UNDERGROUND SCH. 40 GREY PVC	(1) 20 AMP 1-POLE BREAKER FOR GENERATOR BLOCK HEATER	±25'						
6	GENERATOR	ATS	(5) #18 TYPE TC WIRES	N/A	1" RIGID RMC (ABOVE GROUND), UNDERGROUND SCH. 40 GREY PVC	CIRCUIT FOR BATTERY CHARGER & COMMERCIAL POWER SENSING	±25'						
7	ATS	FSEE (ALARM BOX)	(2) CAT 6 CABLES	N/A	1" RIGID RMC (ABOVE GROUND), UNDERGROUND SCH. 40 GREY PVC	ALARM CABLES (RUN INTO ALARM BOX. PROVIDE 24" OF SLACK CABLE. FINAL PUNCH DOWN IS BY GC. LABEL ALL WIRES)	±37'						
8	GENERATOR	E-STOP	(2) #18	N/A	1/2" RIGID RMC (ABOVE GRADE) , UNDERGROUND SCH. 40 GRAY PVC	REMOTE E-STOP FEED TO GENERATOR	±24'						
	* THE CONDUIT L VERIFY LENGTHS				5%. THE EXACT LENGTH TO COMPANIES.	BE VERIFIED IN FIELD							

Know what's below Call 811 before you dig.





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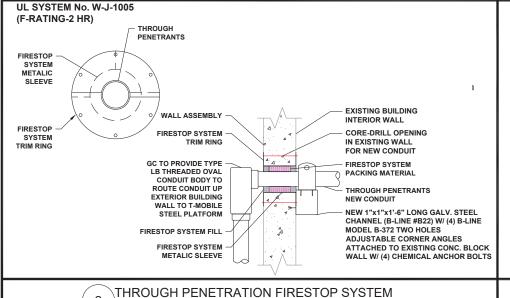
& LABEL "GEN GFCI".

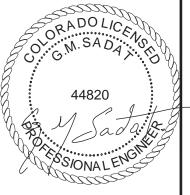
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> SHEET TITLE: UTILITY PLAN AND **DETAILS**

> > SHEET NUMBER

E-1




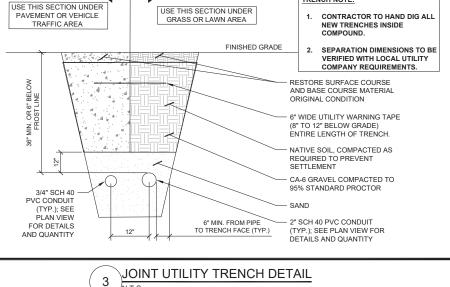

GC TO INSTALL (1) NEW 20 AMP 1-POLE BREAKER FOR GENERATOR BLOCK HEATER REMOVE AND REPLACE BREAKER IN OFF POSITION

PPC DETAILS

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IMPORTANT NOTES:

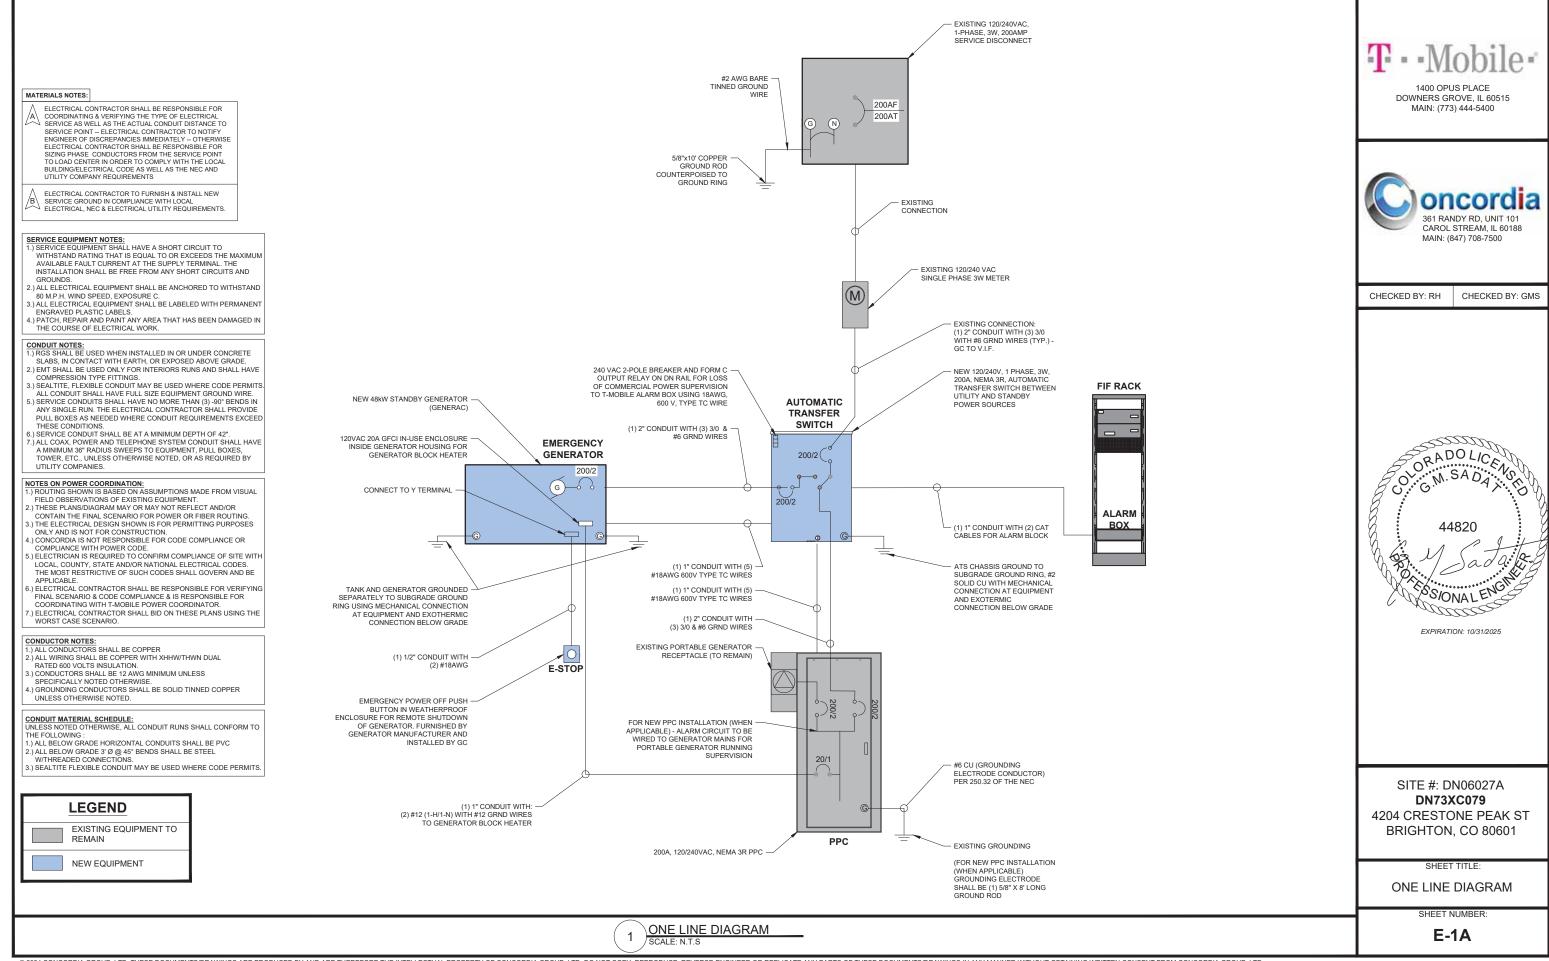PVC JACKET.

A FLAG STYLE LABEL IS TO BE PLACED ON EACH ALARM CABLE
NOT MORE THAN 5" FROM ANY TERMINATION POINT. THE CABLE
LABELS ARE TO DEFINE THE CIRCUIT DESCRIPTION AND POINT
OF TERMINATION ON EACH END OF THE CABLE WITH THE NEAR

2. ALARM WIRING TERMINATIONS SHALL BE RING OR FORK TONGUE

(2) OUTDOOR RATED CAT 6 CABLES TO BE UTILIZED FOR ALARM

CONNECTIONS; POLYOLEFIN INSULATION, RIP CORD AND OUTER

VINYL INSULATED COMPRESSION TYPE, UL-CSA APPROVED

END ("THIS POSITION") AND FAR END ("TO POSITION") INFORMATION AND TERMINATION POINTS.

4. TERMINATIONS FOR SHIELDED ALARM CABLING SHALL BE SIMILAR, WITH TERMINATIONS FOR LOOP AND BRAIDED GROUND

ALL FIELD ALARMS INCLUDING GENERATOR ALARMS ARE TO

ROUTE DIRECTLY TO THE ALARM BOX FOR TERMINATION.


MANUFACTURERS WITH 600V INSULATION.

6. CLEARLY LABEL AND TAG ALL COMPONENTS.

	ALARM LABEL CODING (GENERATOR TO FSEB)											
GENERAC GENE	RATOR	, LOCP RELAY INSTALLED				TERMINATION	AT FSEE	1		TERMINATION AT 0	SENERAT	TOR
NAME	LINE#	DESCRPTION	POLARITY	EAC CABLE	WIRES	TERMINAL BLOCK	WIRES	TERMINAL BLOCK	WIRES	TERMINATION	WIRES	TERMINATION
GENERATOR LOW FUEL	13	NC#5-LOW FUEL	NC	CAT6 TO GENERATOR RELAY	WHITE/BLUE	X4111 PIN 13	BLUE	X4110 PIN 13	WHITE/BLUE	GENERAC CUSTOMER CONNECTION RB4 #3	BLUE	GENERAC CUSTOMER CONNECTION RB4 #2
GENERATOR RUNNING	14	NC#8-GEN RUNNING	NC	CAT6 TO GENERATOR RELAY	WHITE/ORANGE	X4111 PIN 14	ORANGE	X4110 PIN 14	WHITE/ORANGE	GENERAC CUSTOMER CONNECTION RB4 #9	ORANGE	GENERAC CUSTOMER CONNECTION RB4 #8
GENERATOR NOT IN AUTO	15	NC#11-NOT IN AUTO	NC	CAT6 TO GENERATOR RELAY	WHITE/GREEN	X4111 PIN 15	GREEN	X4110 PIN 15	WHITE/GREEN	GENERAC CUSTOMER CONNECTION RB4 #12	GREEN	GENERAC CUSTOMER CONNECTION RB4 #11
GENERATOR ALARM CRITICAL	16	COMMON SHUTDOWN ALARM OUTPUT	NC	CAT6 TO GENERATOR RELAY	WHITE/BROWN	X4111 PIN 16	BROWN	X4110 PIN 16	WHITE/BROWN	GENERAC CUSTOMER CONNECTION TB4 #2	BROWN	GENERAC CUSTOMER CONNECTION TB4 #1
GENERATOR ALARM NSI	17	NC#2-DOOR ALARM	NC	CAT6 TO GENERATOR RELAY	WHITE/BLUE	X4111 PIN 17	BLUE	X4110 PIN 17	WHITE/BLUE	GENERAC CUSTOMER CONNECTION RB4 #6	BLUE	GENERAC CUSTOMER CONNECTION RB4 #5

	ALARM LABEL CODING (GENERATOR TO FSEE)											
GENERAC GENERATOR, LOCP RELAY INSTALLED					TERMII	NATION AT FSEE OF	NLY IF S	TARTS ON 0		TERMINATION AT	GENERA	TOR
NAME	LINE #	DESCRPTION	POLARITY	EAC CABLE	WIRES	TERMINAL BLOCK	WIRES	TERMINAL BLOCK	WIRES	TERMINATION	WIRES	TERMINATION
GENERATOR LOW FUEL	12	NC#5-LOW FUEL	NC	CAT6 TO GENERATOR RELAY	WHITE/BLUE	X4111 PIN 12	BLUE	X4110 PIN 12	WHITE/BLUE	GENERAC CUSTOMER CONNECTION RB4 #3	BLUE	GENERAC CUSTOMER CONNECTION RB4 #2
GENERATOR RUNNING	13	NC#8-GEN RUNNING	NC	CAT6 TO GENERATOR RELAY	WHITE/ORANGE	X4111 PIN 13	ORANGE	X4110 PIN 13	WHITE/ORANGE	GENERAC CUSTOMER CONNECTION RB4 #9	ORANGE	GENERAC CUSTOMER CONNECTION RB4 #8
GENERATOR NOT IN AUTO	14	NC#11-NOT IN AUTO	NC	CAT6 TO GENERATOR RELAY	WHITE/GREEN	X4111 PIN 14	GREEN	X4110 PIN 14	WHITE/GREEN	GENERAC CUSTOMER CONNECTION RB4 #12	GREEN	GENERAC CUSTOMER CONNECTION RB4 #11
GENERATOR ALARM CRITICAL	15	COMMON SHUTDOWN ALARM OUTPUT	NC	CAT6 TO GENERATOR RELAY	WHITE/BROWN	X4111 PIN 15	BROWN	X4110 PIN 15	WHITE/BROWN	GENERAC CUSTOMER CONNECTION TB4 #2	BROWN	GENERAC CUSTOMER CONNECTION TB4 #1
GENERATOR ALARM NSI	16	NC#2-DOOR ALARM	NC	CAT6 TO GENERATOR RELAY	WHITE/BLUE	X4111 PIN 16	BLUE	X4110 PIN 16	WHITE/BLUE	GENERAC CUSTOMER CONNECTION RB4 #6	BLUE	GENERAC CUSTOMER CONNECTION RB4 #5

TERMINATIONS TO FSEB/FSEE

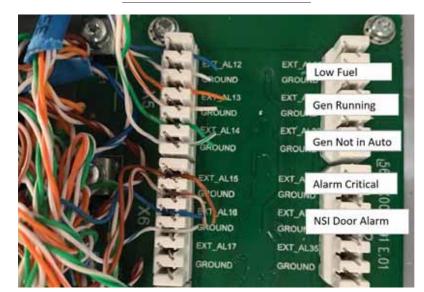


LABELS AT FSEB/FSEE





TERMINATIONS TO GENERATOR

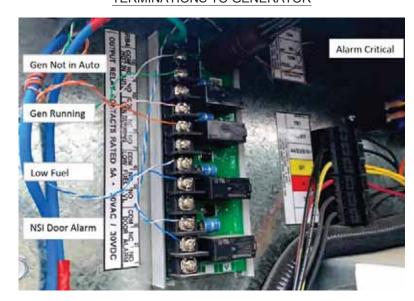

LABELS AT GENERATOR






1400 OPUS PLACE DOWNERS GROVE, IL 60515 MAIN: (773) 444-5400



CHECKED BY: RH

CHECKED BY: GMS

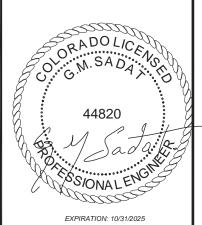


SITE #: DN06027A DN73XC079 4204 CRESTONE PEAK ST BRIGHTON, CO 80601


SHEET TITLE:

ALARM SCHEDULE

SHEET NUMBER:

E-2

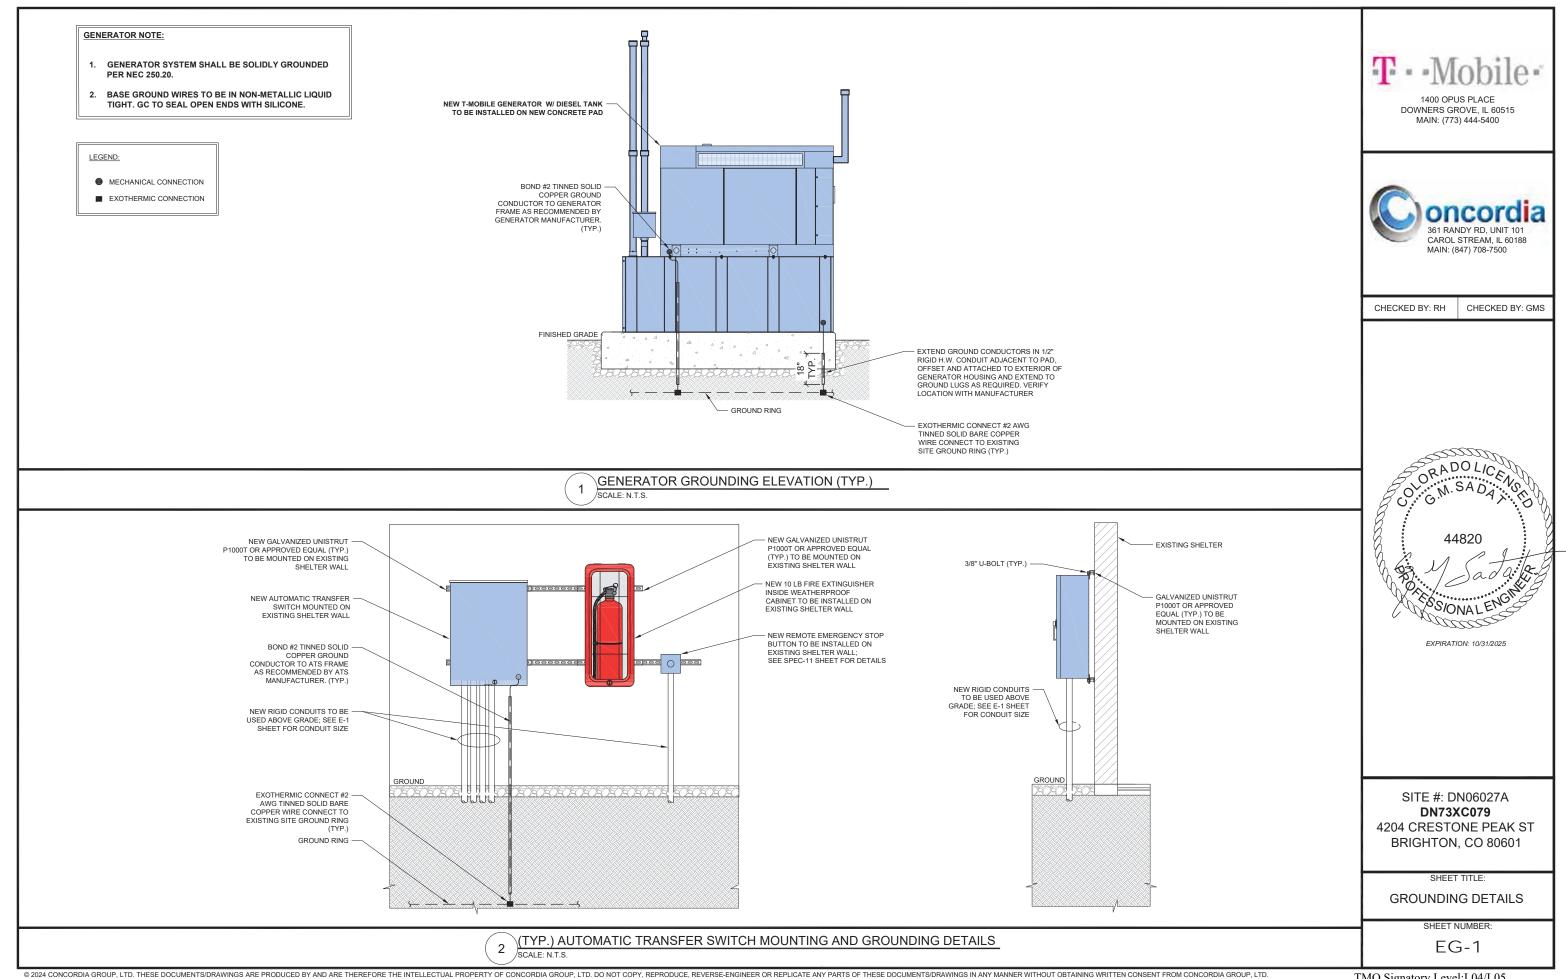

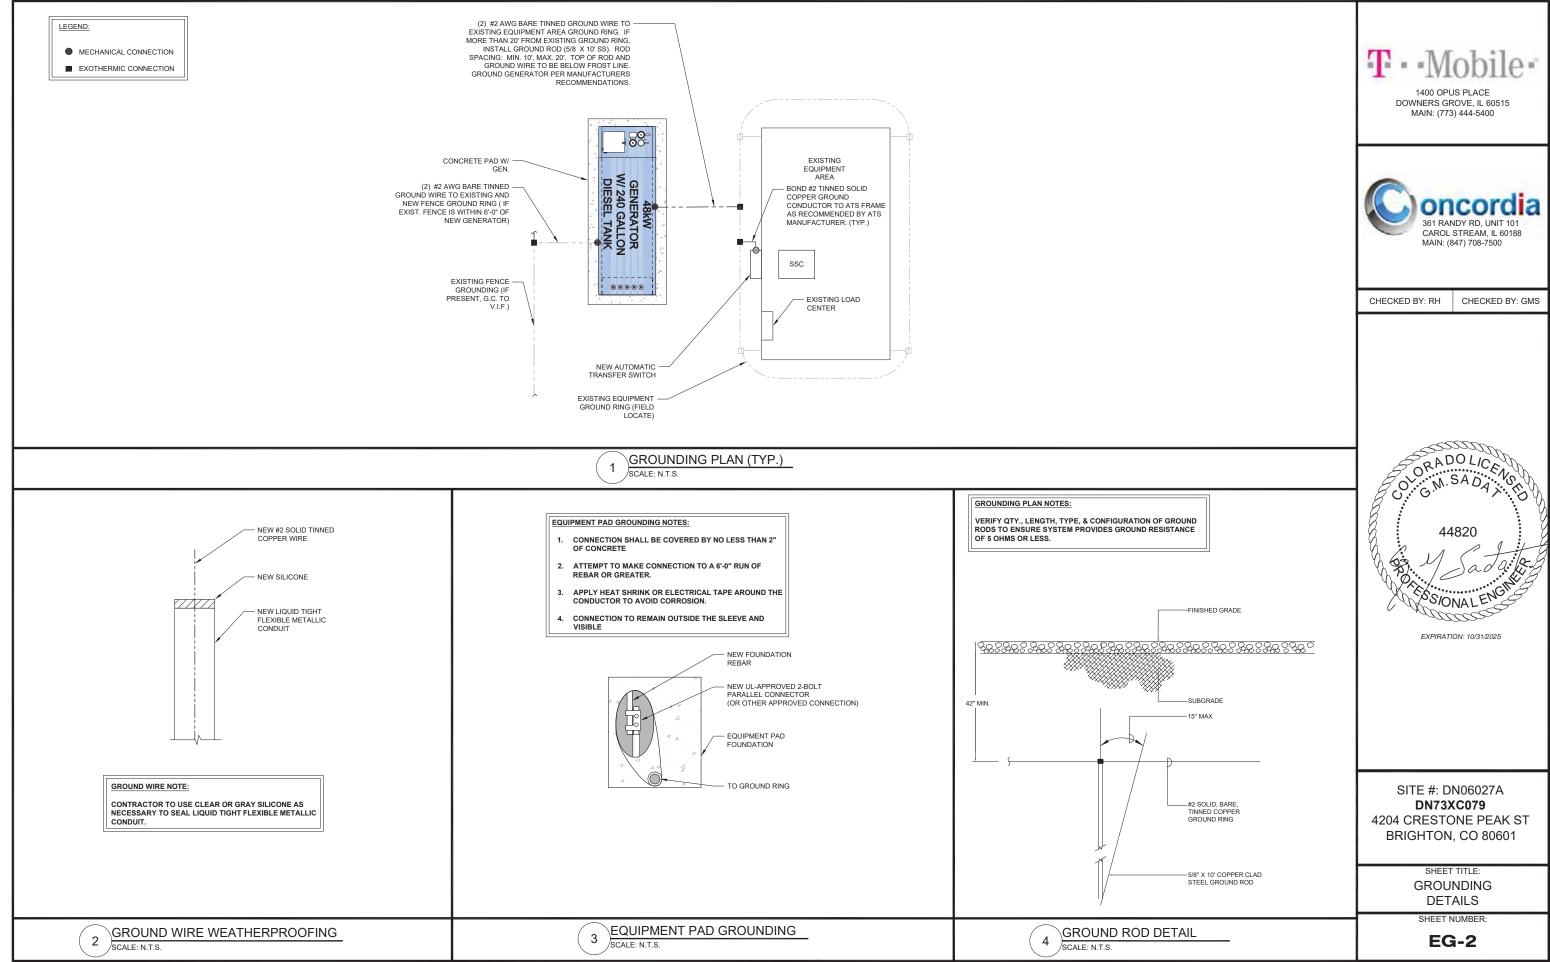

RD048 | 3.3L | 48 kW INDUSTRIAL DIESEL GENERATOR SET

EPA Certified Stationary Emergency

GENERAC INDUSTRIAL

Model Number 48 kW: G0079600

Standby Power Rating

48 kW, 60 Hz


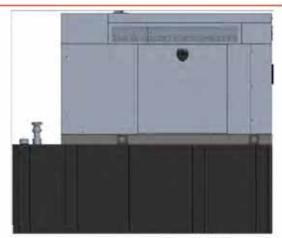


Image used for illustration purposes only

Codes and Standards

Not all codes and standards apply to all configurations. Contact factory for details.



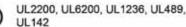





CSA C22.2, ULC S601



BS5514 and DIN 6271



SAE J1349



NFPA 37, 70, 99



ISO 3046, 8528, 9001



NEMA ICS1, ISC10, MG1, 250, ICS6,

ANSI

ANSI/IEEE C62.41

Powering Ahead

For over 60 years, Generac has provided innovative design and superior manufacturing. Generac ensures superior quality by designing and manufacturing most of its generator components, including alternators, enclosures and base tanks, control systems and communications software.

Generac gensets utilize a wide variety of options, configurations and arrangements, allowing us to meet the standby power needs of practically every application. Generac searched globally to ensure the most reliable engines power our generators. We choose only engines that have already been proven in heavy-duty industrial applications under adverse conditions.

Generac is committed to ensuring our customers' service support continues after their generator purchase.

RD048 | 3.3L | 48 kW INDUSTRIAL DIESEL GENERATOR SET

EPA Certified Stationary Emergency

GENERAC INDUSTRIAL

STANDARD FEATURES

ENGINE SYSTEM

- · Block Heater
- · Oil Drain Extension · Fan Guard
- · Factory Filled Oil and Coolant

GENERATOR SET

- · Sound Attenuated Aluminum Enclosure
- · Internal Genset Vibration Isolation
- . Separation of Circuits High/Low Voltage
- · Wrapped Exhaust Piping
- · Standard Factory Testing
- . Ready to Accept Full Load in <10 Seconds
- . External Emergency Stop Push Button

ENCLOSURE

- . Lockable Doors Keyed Lock with Padiock Hasp
- Rust Proof Hardware

CONTROL SYSTEM

· RhinoCoat ** - Textured Polyester Powder Coat

Electrical System

- Battery
- · Battery Charging Alternator
- · Battery Cables
- Battery Tray
- · Rubber-Booted Engine Electrical Connections
- · Sciencid Activated Starter Motor
- · Smart Battery Charger
- · Battery Disconnect

ALTERNATOR SYSTEM

- 2/3 Pitch
- Skewed Stator
- Sealed Bearings
- Low Temperature Rise (<120 °C)
- Low THD (<5%)

Cooling System

- · Closed Coolant Recovery System
- · Factory-Installed Radiator
- · 50/50 Ethylene Glycol Antifreeze · Radiator Drain Extension
- . Can Operate at up to 122 °F (50 °C) Ambient Temperature

Fuel System

- · Primary Fuel Filter
- · Stainless Steel Fuel Lines

FHEI TANKS

- · 48 Minimum Hour Run Time
- UL142/ULC S601 Listed
- · Lockable Fuel Cap



Evolution ** Controller

- . Two-Line Plain Text LCD Display
- . Programmable Start Delay Between 10-30 Seconds
- 10 Second Engire Start Sequence
- . 5 Second Engine Warm Up
- . 1 Minute Engine Cool-Down
- · Starter Lock-Out
- · Smart Battery Charger
- · Automatic Voltage Regulation with Over and Under
- · Automatic Low Ol Pressure Shutdown
- · Overspeed Shutdown
- · High Temperature Shutdown
- Overcrank Protection
- · Safety Fused
- · Failure to Transfer Protection
- · Low Battery Protection
- . 50 Event Run Log
- · Future Set Capable Exerciser
- · Incorrect Wiring Protection
- · Internal Fault Projection

· Not in Auto

- · OBD2 Diagnostic Port Alarms
- · Door Open
- · Fuel Level
 - 90% Full

· Common External Fault Capability

. Governor Failure Protection

- 50% Low Fuel - 10% Shutdown
- · Generator Running
- · Common Shutdown

OPTIONAL SHIPPED LOOSE AND FIELD INSTALL KITS

GENERATOR SET

- · Paint Kit
- · Scheduled Maintenance Kit

FUEL TANK

- · Fuel Fill Drop Tute
- Spill Box
- · 90% Fuel Audible Alarm
- · Tank Risers · Spill Box Drainback Kit
- · Vent Extension Support Kit.
- · Overfill Prevention Valve

SITE #: DN06027A DN73XC079 4204 CRESTONE PEAK ST BRIGHTON, CO 80601

DOWNERS GROVE, IL 60515

MAIN: (773) 444-5400

361 RANDY RD UNIT 101

CAROL STREAM II 60188

CHECKED BY: GMS

MAIN: (847) 708-7500

CHECKED BY: RH

SHEET TITLE: **GENERATOR SPECIFICATIONS**

SHEET NUMBER:

SPEC-1

TMO Signatory Level:L04/L05

RD048 | 3.3L | 48 kW INDUSTRIAL DIESEL GENERATOR SET

GENERAC INDUSTRIAL

EPA Certified Stationary Emergency

APPLICATION AND ENGINEERING DATA

General		Cooling System	
Make	Mitsubishi	Coaling System Type	Closed Recovery
Cylinder #	4	Fan Type	Pusher
Туре	In-Line	Fan Speed - RPM	2,340
Displacement - in ³ (L)	201.38 (3.3)	Fan Diameter - in (mm)	17 (431.8)
Bore - in (mm)	3.70 (94)		
Stroke - in (mm)	4.72 (120)	Fuel System	
Compression Ratio	19:1	Fuel Type	Ultra Low Sultur Diesel Fuel
Cylinder Head Type	Cast Iron OHV	Fuel Specification	ASTM
Piston Type	Aluminum	Fuel Pump Type	Mechanical Engine Driven Gear
Intake Air System	Turbocharged/Aftercooled	Injector Type	Mechanical
		Fuel Supply Line - in (mm)	0.31 (7.94) ID
Engine Governing		Fuel Return Line - in (mm)	0.31 (7.94) 10
Governor	Electronic	Fuel Filtering (Microns)	6
Frequency Regulation (Steady State)	±0,25%	Engine Electrical System	
Lubrication System		System Voltage	12 VDC
Oil Pump Type	Gear	Battery Charger Alternator	Standard
Oil Filter Type	Full Flow Spin-On Canister	Battery Size	Group 27F
Crankcase Capacity - qt (L)	11.2 (10.6)	Battery Voltage	12 VDC
		Ground Polarity	Negative

ALTERNATOR SPECIFICATIONS

Standard Model	Generac	
Poles	4	
Field Type	Ratating	
Insulation Class - Rotor	F	
Insulation Class - Stator	Н	
Total Harmonic Distortion	<5%	
Telephone Interference Factor (TIF)	<50	

Standard Excitation	Direct	
Bearings	Single Sealed Cartridge	
Coupling	Direct via Flexible Disc	
Prototype Short Circuit Test	Yes	
Voltage Regulator Type	Electronic	
Regulation Accuracy (Steady State)	±1.0%	

RD048 | 3.3L | 48 kW

INDUSTRIAL DIESEL GENERATOR SET

EPA Certified Stationary Emergency

OPERATING DATA

POWER RATINGS

 Standby

 Single-Phase 120/240 VAC ⊚1.0pf
 48 kW
 Amps: 200
 Circuit Breaker Size Amps: 200

MOTOR STARTING CAPABILITIES (skVA)

skVA vs. Voltage Dip at 30% 120/240 V, Single-Phase at 0.4pf 189 Amps

FUEL CONSUMPTION RATES*

Percent Load	Diesel gph (Lph)
25%	1.23 (4.66)
50%	2.02 (7.66)
75%	3.02 (11.43)
100%	4.02 (15.22)

 Fuel supply installation must accommodate fuel consumption rates at 100% load.

COOLING

		Standby
Air Flow	cfm. (m³/min)	3,038 (86)
Coolant System Capacity	gal (L)	2.8 (10.6)
Heat Rejection to Coolant	BTU/hr (MJ/hr)	111,000 (117.1)
Temperature Deration	3% for every 5 °C above 25	°C or 1.7% for every 5 °F over 77 °F
Attitude Deration	1% for every 100 m above 915	m or 3% for every 1,000 ft over 3,000 ft
Maximum Ambient Temperature Operating Range	*F (*C)	50 (122)
Maximum Radiator Backpressure	in H ₂ O (kPa)	0.5 (0.12)

COMBUSTION AIR REQUIREMENTS

	Standby
How at Rated Power - cfm (m3/min)	90 (2.5)

ENGINE			EXHAUST		
		Standby			Standby
Rated Engine Speed	RPM	1,800	Exhaust Flow (Rated Output)	cfm (m³/min)	230 (6.5)
			Exhaust Temperature (Rated Output)	"F ("C)	930 (499)

Deration – Operational characteristics consider maximum ambient conditions. Derate factors may apply under atypical site conditions.

Please contact a Generac Power Systems Industrial Dealer for additional details. All performance ratings in accordance with ISO3046, BS5514, ISO8528, and DIN6271 standards.

T·Mobile

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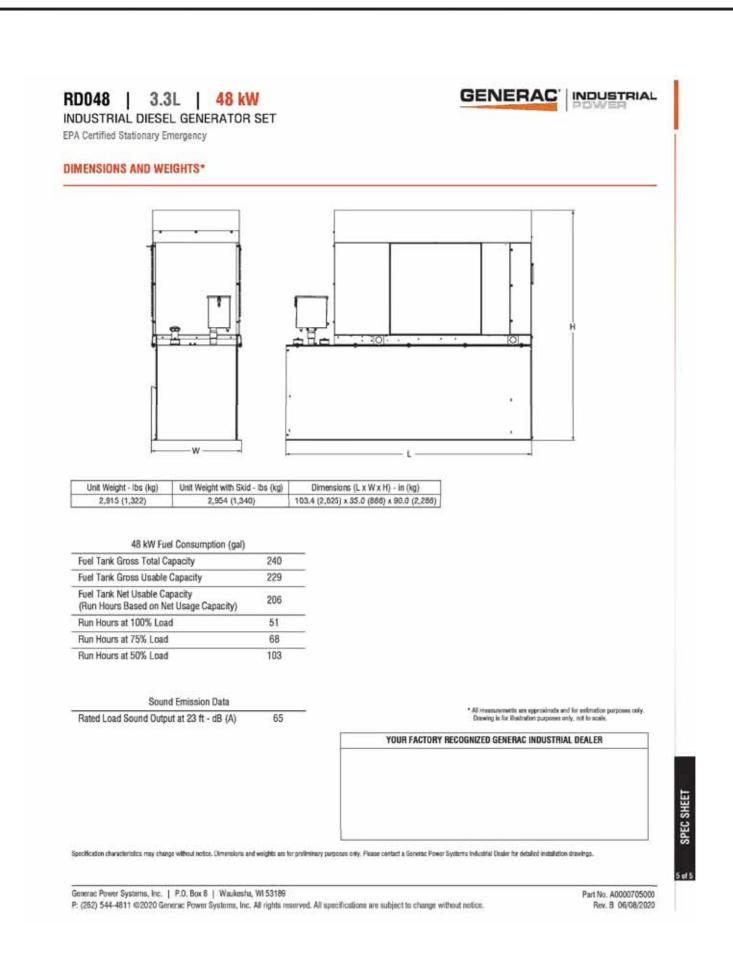
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SPEC SHEET

SITE #: DN06027A DN73XC079 4204 CRESTONE PEAK ST BRIGHTON, CO 80601

SHEET TITLE:
GENERATOR
SPECIFICATIONS

SHEET NUMBER:









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SITE #: DN06027A DN73XC079 4204 CRESTONE PEAK ST BRIGHTON, CO 80601

SHEET TITLE:
GENERATOR
SPECIFICATIONS

SHEET NUMBER:



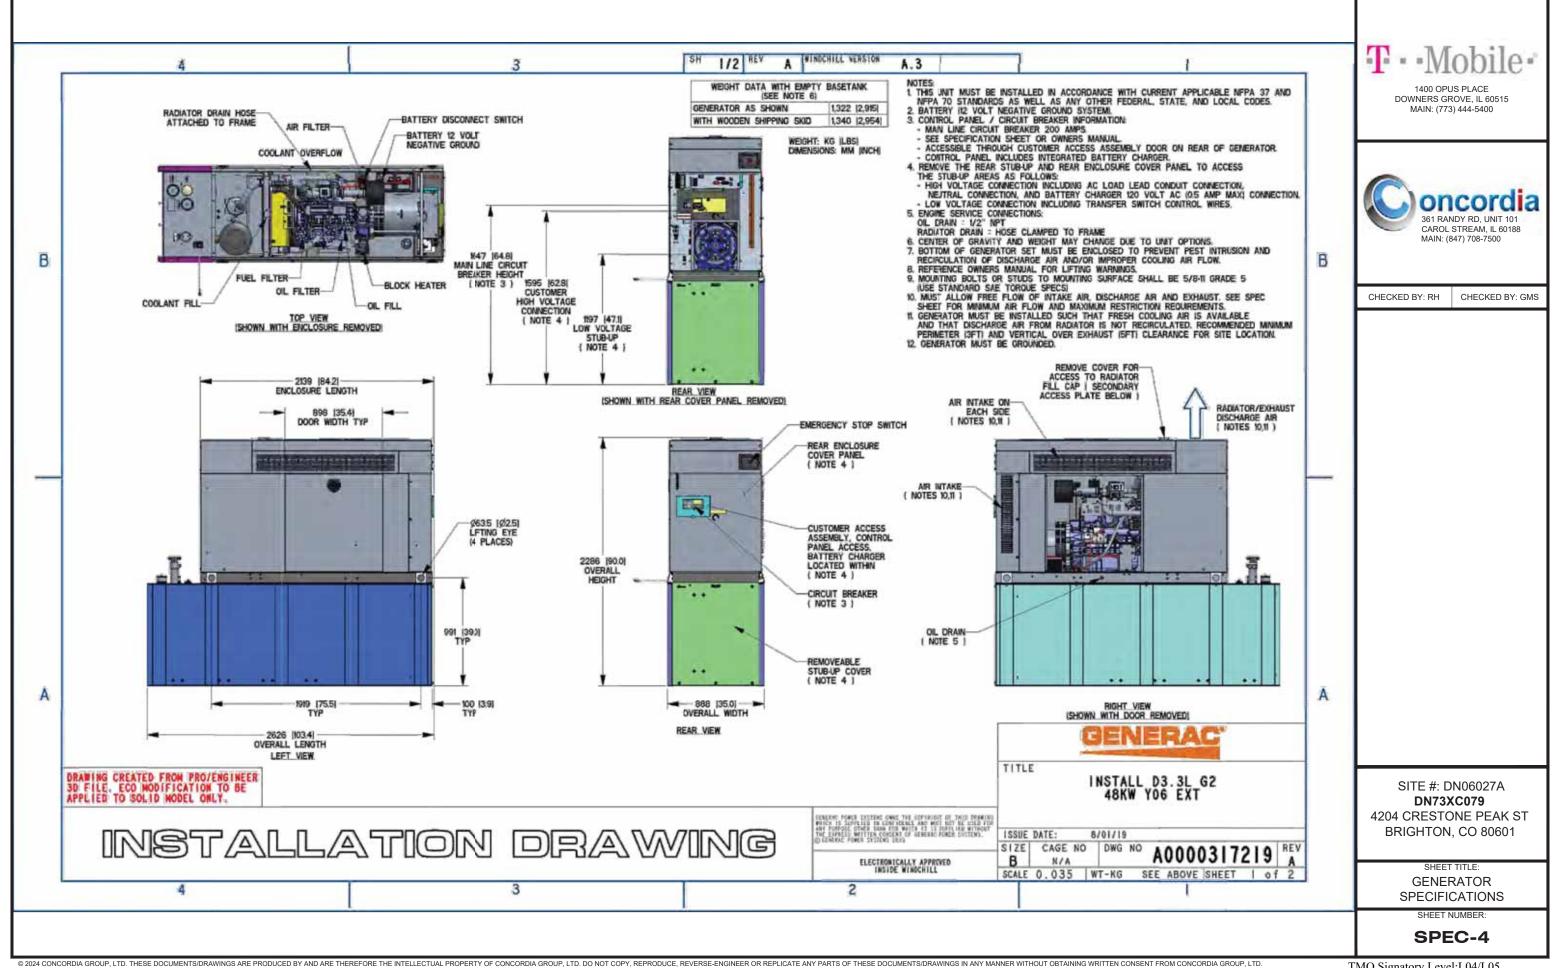

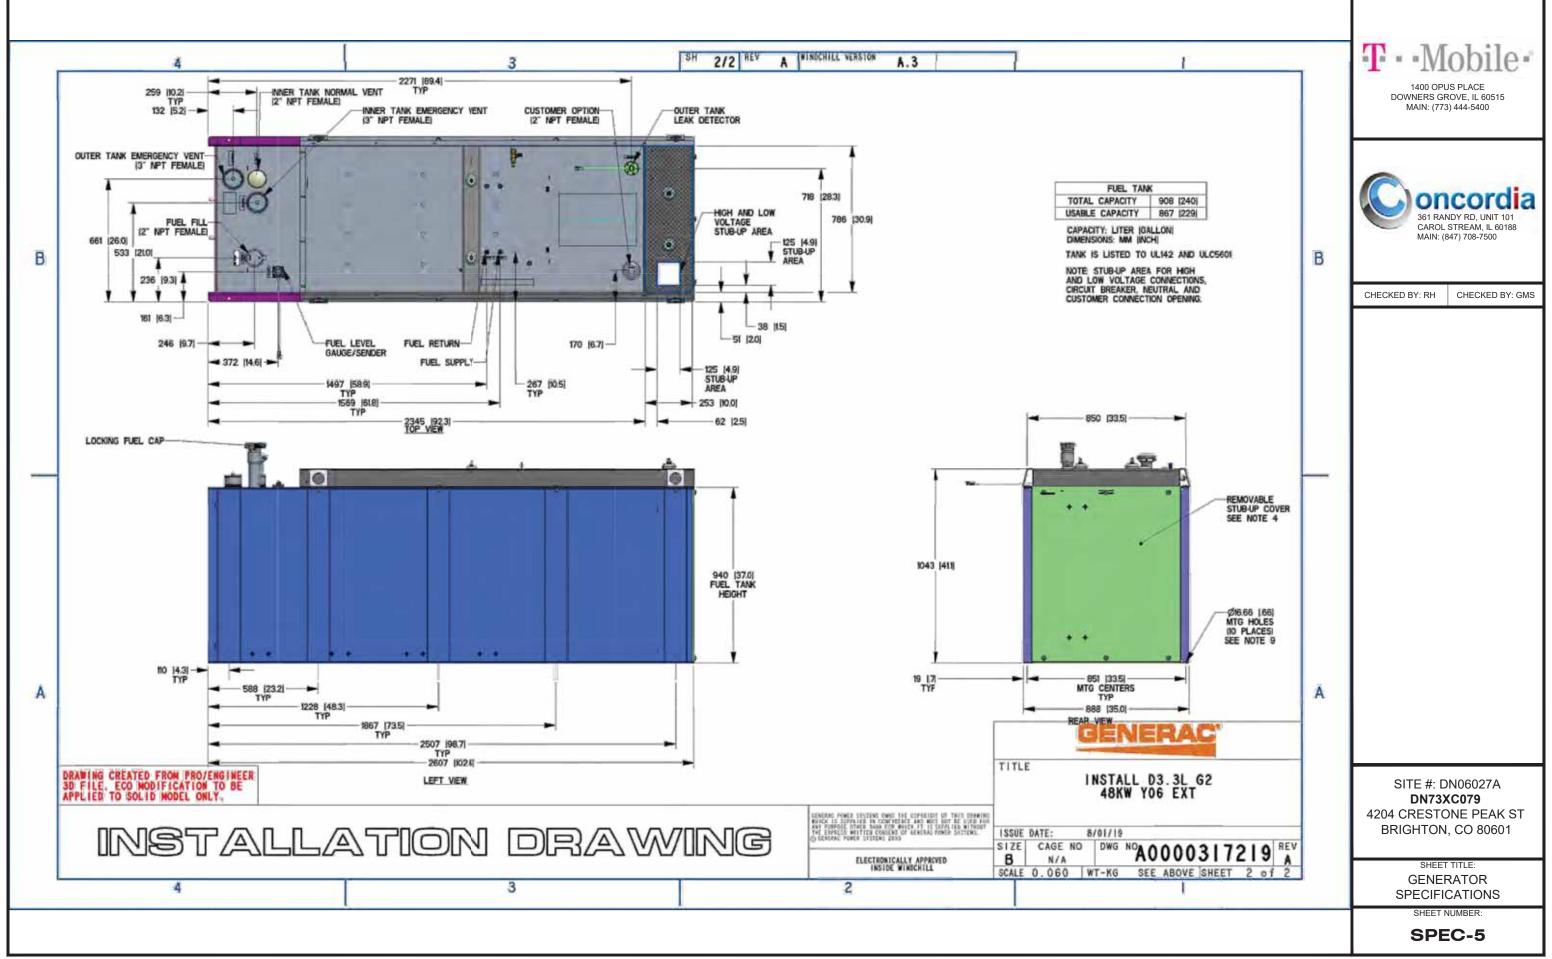



Service and Non-Service Rated **Automatic Transfer Switches**

1 of 3 2 of 3





Models: RXSC100A3 RXSW100A3 RXSW150A3 RXSC200A3 RXSW200A3





Description

This series of Generac Automatic Transfer Switches is designed for use with single phase generators that utilize an Evolution " or Nexus" Controller. The 100 and 200 Amp open transition switches are available in single phase in both service equipment rated and non-service equipment rated configurations. The 150 Amp open transition switch is only available in a service rated equipment configuration.

Standard Features

Service rated (RXSW) Generac Automatic Transfer Switches are housed in an aluminum NEMA Type 3R enclosure*, with electrostatically applied and baked powder paint. The Heavy Duty Generac Contactor is an ETL recognized device, designed for years of service. The controller at the generator handles all the timing, sensing, exercising functions, and transfer commands. All switches are covered by a five year limited warranty.

* Non-service rated (RXSC) switches are housed in a steel enclosure.

Load Management Technology

Through the use of the integrated Smart A/C Module (SACM), these switches have the capability to manage up to four individual HVAC (24 WAC controlled) loads with no additional hardware. When used in tandern with external Smart Management Modules, a total of eight more loads can be managed, providing the most installation efficient power management options available.









Functions

All timing and sensing functions originate in the generator controller.

<65%
10 Second Factory Set, Adjustable Between 2 - 1,500 Seconds by a Qualified Dealer*
5 Seconds
65% for 5 Seconds
>80%
15 Seconds
60 Seconds
Nexus **: 12 Minutes Weekly Evolution **: 5 to 12 Minutes Adjustable, Weekly/Bi-weekly/Monthly

^{*} When used in conjunction with units utilizing Evolution " contrals.

Specifications

Model	RXSC100A3	RXSW100A3	RXSW150A3	RXSC200A3	RXSW200A3
Amps	100	100	150	200	200
Voltage	120/240, 1ø	120/240, 1ø	120/240, 18	120/240, 1ø	120/240, 1ø
Load Transition Type (Automatic)	Open Transition	Open Transition Service Rated	Open Transition Service Rated	Open Transition	Open Transition Service Rated
Enclosure Type	NEMA 3R	NEMA 3R	NEMA 3R	NEMA 3R	NEMA 3R
ETL Rating	cETLus	ETLus	ETLus	cETLus	ETLus
Withstand Rating (Amps)	10,000	10,000	22,000	10,000	22,000
Lug Range	2/0 - #14			250 MCM - #6	





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SITE #: DN06027A DN73XC079 4204 CRESTONE PEAK ST BRIGHTON, CO 80601

> SHEET TITLE: ATS **SPECIFICATIONS**

SHEET NUMBER:




100-200 Amps, Single Phase

Automatic Transfer Switches

Dimensions

Model		RXSC100A3	RXSW100A3	RXSW150A3	RXSC200A3	RXSW200A3
	H1	17.2 (437.9)	17.2 (437.9)	26.8 (679.4)	17.2 (437.9)	26.8 (679.4)
Height - in (mm)	H2	20.0 (508.0)	20.0 (508.0)	30.0 (672.0)	20.0 (508.0)	30.0 (672.0)
	W1	12.5 (317.5)	12.5 (317.5)	10.5 (266.7)	12.5 (317.5)	10.5 (266.7)
Width - in (mm)	W2	14.6 (370.8)	14.6 (370.8)	13.5 (342.9)	14.6 (370.8)	13.5 (342.9)
Depth - in (mm)		7.1 (180.1)	7.1 (180.1)	8.3 (160.1)	7.1 (180.1)	6.3 (160.1)
Weight - Ibs (kg)		20.0 (9.1)	22.5 (10.2)	39.0 (17.7)	20.0 (9.1)	39.0 (17.7)

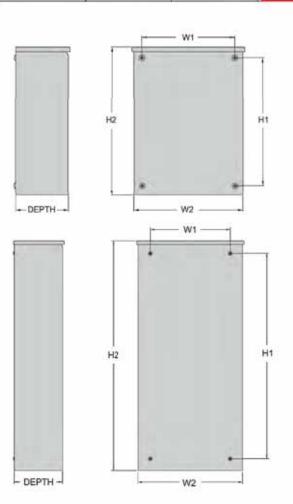



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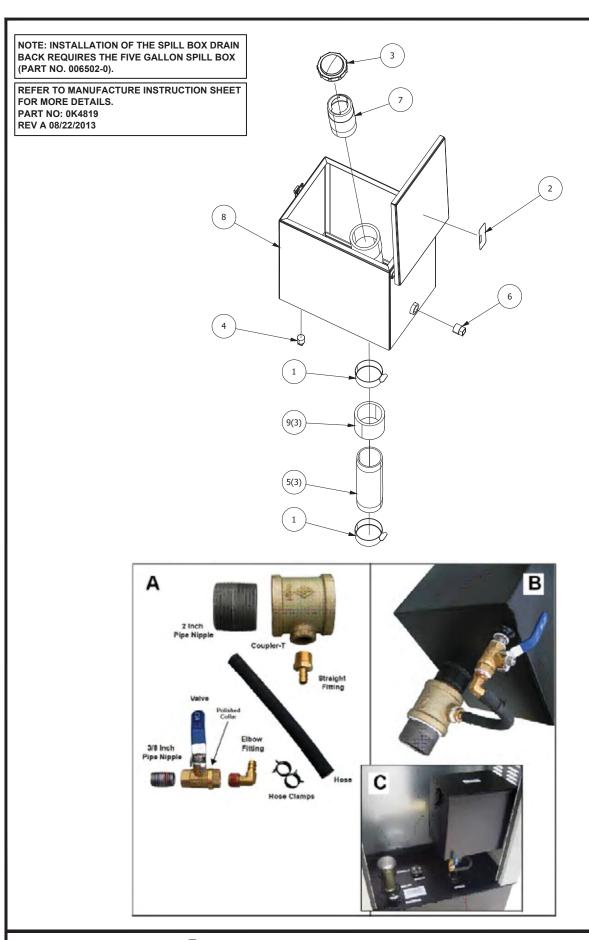
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SITE #: DN06027A DN73XC079 4204 CRESTONE PEAK ST BRIGHTON, CO 80601

> SHEET TITLE: ATS **SPECIFICATIONS**

> > SHEET NUMBER:




IMPORTANT: FOLLOW ALL SAFETY PROTOCOLS AND REMOVE THE UNIT FROM SERVICE AS OUTLINED IN THE OWNER'S MANUAL (PART NO. 0K3220) BEFORE PERFORMING THIS UPGRADE.

NOTES:

- THE SIDE OF THE ENCLOSURE WITH THE VIEWING WINDOW IS IDENTIFIED AS THE REAR OF THE GENERATOR SET. THE RIGHT AND LEFT SIDES ARE IDENTIFIED BY STANDING AT THE REAR AND LOOKING TOWARDS THE FRONT OF THE UNIT.
- 2. VERIFY GROMMET IS PRESENT OR SHARP EDGES OF HOLE MAY CAUSE CABLE DAMAGE, POSSIBLY RESULTING IN EQUIPMENT FAILURE.
- . IF NECESSARY, REMOVE TOP AND BOTTOM SCREWS (WITH NYLON WASHERS)
 ON LEFT SIDE OF CONTROL PANEL, LOOSEN RIGHT SIDE SCREWS, AND
 ROTATE DOOR OUTWARD TO ACCESS BACK SIDE.
- 4. IF CONTROL PANEL DOOR WAS OPENED FOR CABLE CONNECTION, CLOSE DOOR, INSTALL TOP AND BOTTOM SCREWS (WITH NYLON WASHERS) ON LEFT SIDE. AND TIGHTEN RIGHT SIDE SCREWS.

REFER TO MANUFACTURE INSTRUCTION SHEET FOR MORE DETAILS. PART NO: 0K4251 REV A 08/22/2013

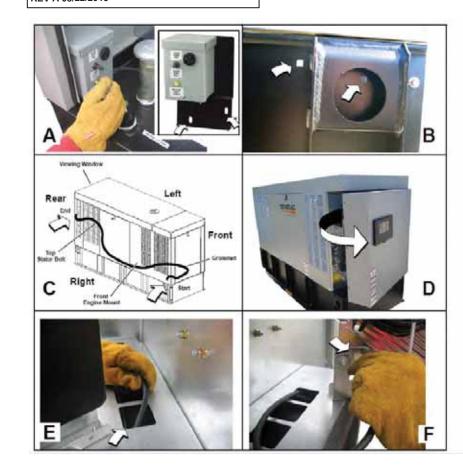

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SITE #: DN06027A DN73XC079 4204 CRESTONE PEAK ST BRIGHTON, CO 80601

SHEET TITLE:

SPILL BOX

SHEET NUMBER:


SPEC-8

SPILL BOX DRAIN BACK (MODEL NO. 006511-0)

SCALE: N.T.S.

2 INSTALL 90% FUEL FILL LEVEL ALARM (MODEL NO. 006504-0)
SCALE: N.T.S.



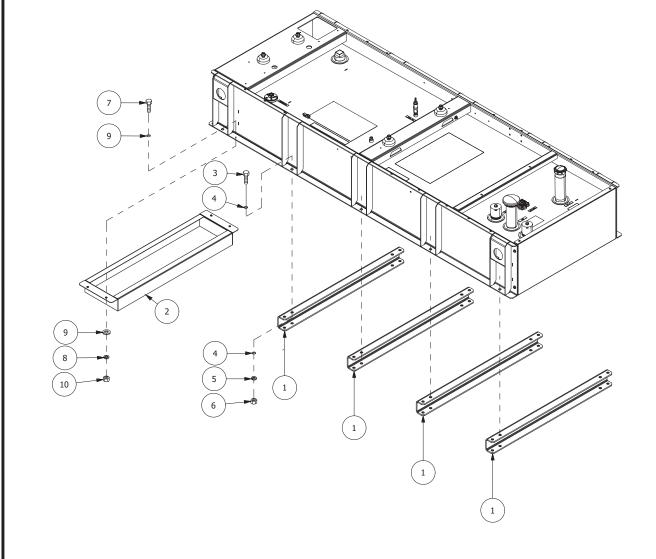

REFER TO MANUFACTURE INSTRUCTION SHEET FOR MORE DETAILS.
REVISION: -ADATE: 2/21/19

DRAWING NO: A0000147657

ITEM	PART#	QTY.	DESCRIPTION
(1)1	0H5230	1	OIL HEATER MAGNETIC 200W
2	0J6251	1	RTV, OIL HEATER
3	0H5987	1	ALCOHOL WIPE (NOT SHOWN)
4	074169	1	SHIPPING CARTON #4 (NOT SHOWN)




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SITE #: DN06027A DN73XC079 4204 CRESTONE PEAK ST BRIGHTON, CO 80601


SHEET TITLE:

VENT KIT

SHEET NUMBER:

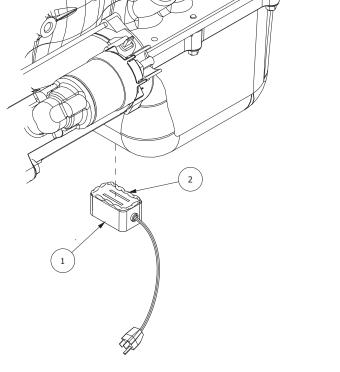SPEC-9

2 CRANK CASE HEATER (EV KIT OIL HEATER W/ PLUG)
SCALE: N.T.S.

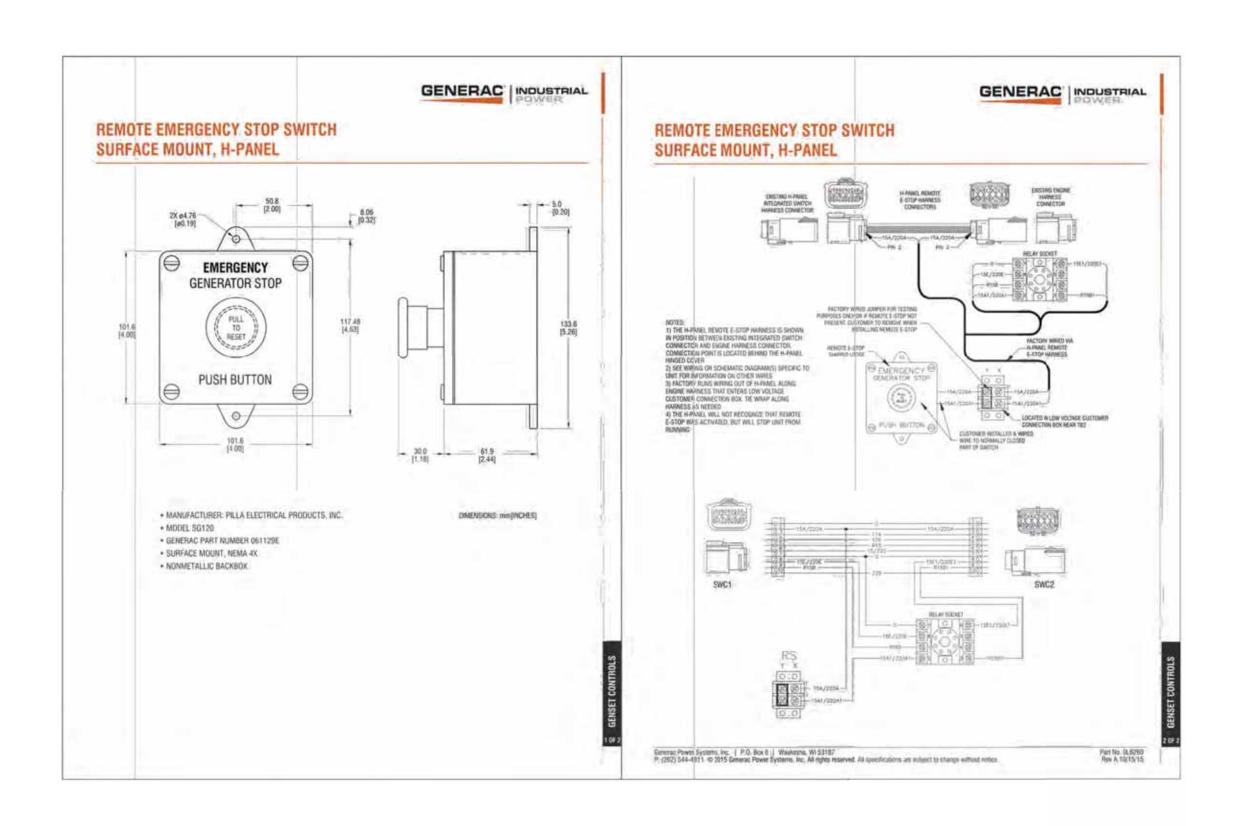



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CHECKED BY: RH

CHECKED BY: GMS

SITE #: DN06027A

DN73XC079

4204 CRESTONE PEAK
ST BRIGHTON, CO 80601

ST BRIGHTON, CO 80601

SHEET TITLE:
REMOTE EMERGENCY STOP
BOTTON

SHEET NUMBER:

EXHIBIT C Memorandum of Lease

[CONFIRM HEADING/MARGINS/FORMAT CONFORM TO STATE AND LOCAL REQUIREMENTS]

(Separate Document to be Executed)

Memorandum of Lease

After Recording, Mail To: T-Mobile USA, Inc. 12920 SE 38th Street Bellevue, WA 98006 Attn: Lease Compliance Site Number: <Site Number.>

APN: 0156910212001

Loan No.

MEMORANDUM OF LEASE

A Site Lease Agreement (the "<u>Lease</u>") by and between the **CITY OF BRIGHTON**, a Colorado home rule municipal corporation ("<u>Landlord</u>") and **T-MOBILE WEST LLC**, a Delaware limited liability company("<u>Tenant</u>") was made regarding a portion of the following property (as more particularly described in the Lease, the "Premises"):

See Attached **Exhibit A** incorporated herein for all purposes.

Without limiting the terms and conditions of the Lease, Landlord and Tenant hereby acknowledge the following:

- 1. Capitalized terms used, but not otherwise defined herein, shall have the meanings ascribed to such terms in the Lease.
- 2. The initial term of the Lease shall be for 10 years and will commence on the Effective Date.
- 3. Tenant shall have the right to extend the Lease two (2) additional and successive five (5) year terms which may be extended for up to two (2) addition and successive one-year periods.
- 4. This memorandum is not a complete summary of the Lease. It is being executed and recorded solely to give public record notice of the existence of the Lease with respect to the Premises. Provisions in this memorandum shall not be used in interpreting the Lease provisions and in the event of conflict between this memorandum and the said unrecorded Lease, the unrecorded Lease shall control.

Site Number: DN06027A/DN73XC079
Site Name: City of Brighton Water Tank

5. This memorandum may be signed in any number of counterparts, each of which shall be an original, with the same effect as if the signatures thereto were upon the same instrument.

IN WITNESS WHEREOF, the parties hereto have respectively executed this memorandum effective as of the date of the last party to sign.

LANDLORD: CITY OF BRIGHTON	I			
Ву:				
Printed Name: Michael Martine	Z			
Title: City Manager				
Date:				
STATE OF COLORADO)				
)ss. COUNTY OF ADAMS)				
This instrument was ack Martinez, in his capacity as City				
Dated:				
	7			
	Notary Public		_	
	Print Name My commission exp			
	iviy commission exp	лгеs <u></u>		
	_			
APPROVED AS TO FORM:				
Yasmina Gibbons, Deputy City A	ttorney			

Site Number: DN06027A/DN73XC079
Site Name: City of Brighton Water Tank

Market: Central

[Signatures and acknowledgements continue on following page.]

T-MOBILE WEST LLC

TENANT:

By:	te Only	
Printed Name: Examp	Documen	
Title Se	parate	
By:		
<u></u>		
[Notary block for Tenant]		
STATE OF		
COLINTY OF) ss.	
COUNTY OF)	
the person who appeared before oath stated that she/he w	have satisfactory evidence that	owledged it as the ware limited liability
companyto be the free and vol	luntary act of such party for the uses and purposes mention	ed in the instrument.
Dated:		
	Notary Public	
	Print Name	
	My commission expires	
(Use this space for notary stamp/seal	I)	

Site Number: DN06027A/DN73XC079 Site Name: City of Brighton Water Tank

Memorandum of Lease - Exhibit A Legal Description

Property address of 19150 E. 160th Ave., Brighton, CO 80601 Assessor's tax parcel number 0156910212001

The Property is legally described as follows:
TRACT A, BRIGHTON CROSSING FILING NO.4,
CITY OF BRIGHTON, COUNTY OF ADAMS, STATE OF COLORADO

Site Number: DN06027A/DN73XC079
Site Name: City of Brighton Water Tank